

WARRINGTON WATERFRONT WARRINGTON

PRELIMINARY PLANNING ADVICE FLOOD RISK, DRAINAGE, UTILITIES & HAZARDS





Limitations

All findings, recommendations and conclusions contained in this report are based on information provided to us during investigations. Shepherd Gilmour Infrastructure Ltd. has created the report based on the assumption that all the information is accurate and accepts no liability should additional information exist or become available.

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Shepherd Gilmour Consulting Engineers

SECTION I INTRODUCTION

1.1. Shepherd Gilmour Infrastructure Ltd (SGi) has been engaged by Peel Investments (North) Ltd (hereafter "the Applicant") to provide Preliminary Planning Advice on Flood Risk, Drainage, Utilities and Hazards in support of the Warrington Waterfront scheme, during the forthcoming representations to the Warrington Borough Council.

SITE LOCATION

- 1.2. The proposed development site (PDS) is in South Warrington and located between the Manchester Ship Canal (MSC) and the River Mersey. The site is irregular in shape spans and approximately 275ha in total (**Figure 1.2**). A full-size copy of this plan has been included within **Appendix A.**
- 1.3. The existing site currently consists of the port developments to the south, the wood land to the north and fields/low lying areas to the east.

Nearest Postcode: WA4 6XE

OS Coordinates: 358227E, 385557N

OS Grid Reference: SJ582855



Figure I.I Site Location (Google)



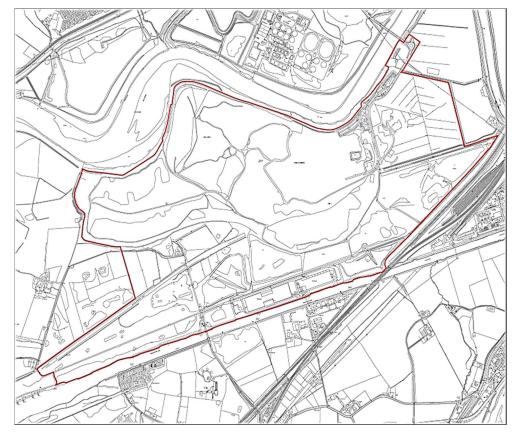


Figure 1.2 Site Boundary (AEW)

PRELIMINARY PROPOSALS

- 1.4. The client's proposals for the Port Warrington development is separated into three distinct areas as shown in **Figure 1.3**;
 - Port Warrington Extension
 - Arpley Meadows Business Park
 - Arpley Meadows Public Open Space

Port Warrington Extension

1.5. The client's proposals for the Port Warrington site is to extend the existing port along the MSC in a westerly direction. The existing/consented development spans approximately 39 ha and will be increased to cover an area of 79ha.

Arpley Meadows Business Park

- 1.6. The clients intend to redevelop the land east of the Arpley Landfill to a new business park. The proposed development will span approximately 33 ha and will utilise the existing highway infrastructure.
- 1.7.

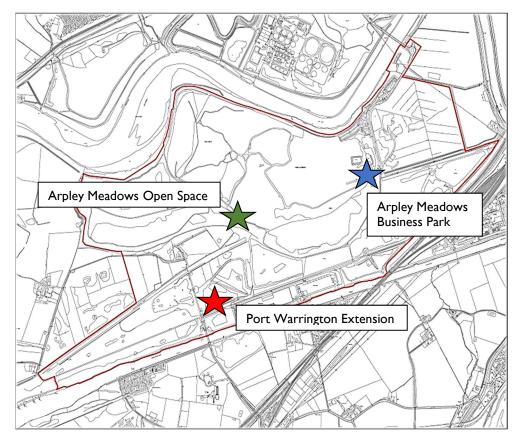


Figure 1.3 Development Areas

Arpley Meadows Open Space

1.8. The client intends to redevelop the existing land fill to create a large area public space (POS). The open space will fill in the area between the port and business park and will vary in use. The OPS will span approximately 163 ha.

Proposed Development Plans

1.9. At this stage the development plans are limited but copies of preliminary sketches have been included within **Appendix B**.



TOPOGRAPHY

Port Warrington Extension

1.10. Based on the Ordnance survey maps the site ranges in level between 10-20m AOD.
The topography within the development area generally falls towards the onsite waterbodies and/or the Manchester Ship Canal.

Arpley Meadows Business Park

1.11. Due to the previous land use (landfill) the Ordnance survey maps has omitted/removed the topography data. However, based on LIDAR information the site ranges between 10-15m AOD (ditches 5m AOD).

Arpley Meadows Public Open Space

1.12. The topography for the area proposed as POS falls from top of the earth/landfill mound (40m AOD) to the surrounding onsite and adjacent waterbodies.

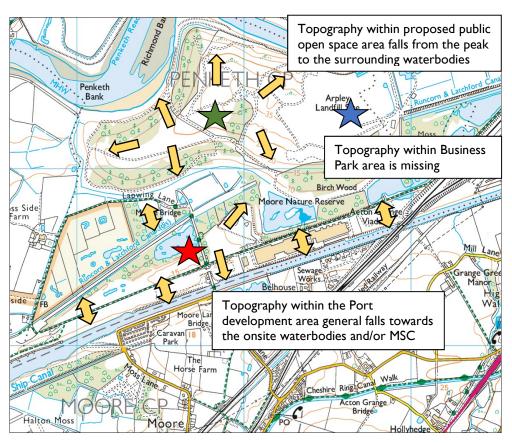


Figure 1.4 OS Plan Topography (OS Map)



SECTION 2 PRELIMINARY FLOOD RISK ADVICE

GOV.UK PLANNING ADVICE MAPS

- 2.1. The Gov.UK online Flood Advice Maps provide a brief overview of the Flood Risk onsite and in the surrounding area. The Flood Advice Map in **Figure 2.1** indicates that the;
 - Port Warrington Extension is within Flood Zones 1, 2 and 3
 - Arpley Meadows Business Park is within Flood Zone I
 - Arpley Meadows Public Open Space is within Flood Zones 1 and 3.
- 2.2. Note that the Flood Advice Map indicates that the proposed Arpley Meadows POS is within Flood Zone 3. This however, is highly unlikely due to the known topography and is probable due to the maps use of historic data.
- 2.3. The existing land fill area has since been upfilled and is higher than adjacent land. Therefore, most of the proposed POS will likely be within Flood Zone 1.

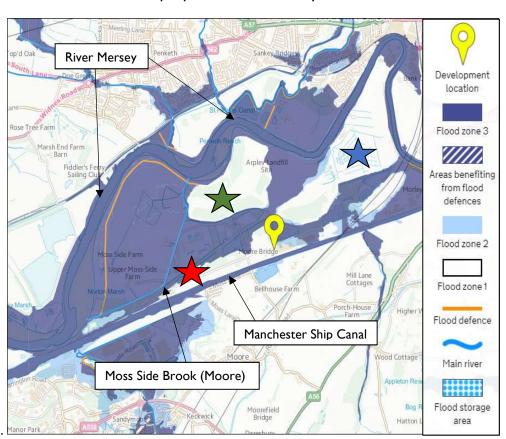


Figure 2.1 Flood Map for Planning (Gov.UK)



Flood Zone Definition

- Flood Zone I (Low Probability) land assessed as having a less than I in 1,000 annual probability of river or sea flooding (<0.1%)
- Flood Zone 2 (Medium Probability) land assessed as having between a 1 in 100 and 1 in 1,000 annual probability of river flooding (1% 0.1%), or between a 1 in 200 and 1 in 1,000 annual probability of sea flooding (0.5% 0.1%) in any year
- Flood Zone 3 (High Probability) land assessed as having a 1 in 100 or greater annual probability of river flooding (>1%), or a 1 in 200 or greater annual probability of flooding from the sea (>0.5%) in any year

ENVIRONMENT AGENCY DATA

2.4. The most current flooding data and maps have been requested from the Environment Agency (EA). Their detail flood map is very similar to the Gov.UK map and does not take into account the recent level changes onsite.

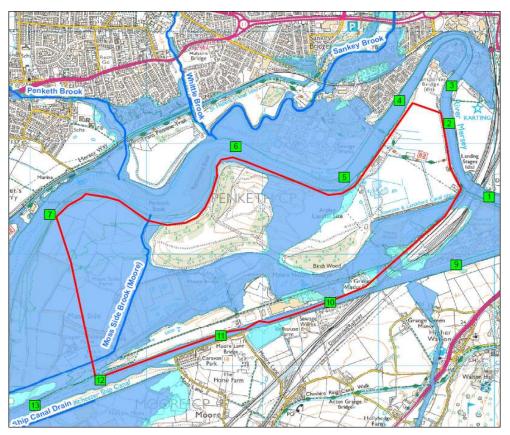


Figure 2.2 Detailed Flood Map (EA)



FLOOD ZONE GUIDANCE

- 2.5. The following information within **Table 2.1 & 2.3** has been taken from the Flood Risk and Coastal Change Guidance Document and specifies which, development type is suitable for each Flood Zone.
- 2.6. The preliminary development plans within **Appendix B** indicates that the proposed land uses for Warrington Waterfront will be;
 - Port Warrington Extension Water compatible and/or Less Vulnerable
 - Arpley Meadows Business Park Less Vulnerable
 - Arpley Meadows Public Open Space Water compatible
- 2.7. These proposed development types/land uses are suitable within the Flood Zones identified in **Figure 2.1** (Flood Advice Map).

Highly Vulnerable	 Police stations, Ambulance stations and Fire stations and Command Centres. Basement dwellings. Caravans, mobile homes & park homes intended for permanent residential use. Installations requiring hazardous substances consent.
More Vulnerable	 Hospitals. Residential institutions Residential dwelling, student halls, drinking establishments/nightclubs and hotels. Non-residential - Health services, nurseries and educational establishments. Landfill and sites used for waste management facilities for hazardous waste.
Less Vulnerable	 Police, ambulance and fire stations which are not required during a flood. Shops; financial, professional and other services; restaurants and cafes; hot food takeaways; offices; general industry; storage and distribution; non-residential institutions not included in 'more vulnerable'; and assembly and leisure. Land and buildings used for agriculture and forestry. Waste treatment (except landfill and hazardous waste facilities). Minerals working and processing (except for sand and gravel working). Water treatment works which are not required during times of flood. Sewage treatment works.
Water Compatible	 Flood control infrastructure. Water transmission infrastructure and pumping stations. Sewage transmission infrastructure and pumping stations. Docks, marinas and wharves. Navigation facilities. MOD defence installations. Ship building, repairing and dismantling, dockside fish processing and refrigeration and compatible activities requiring a waterside location. Water-based recreation (excluding sleeping accommodation). Amenity open space, nature conservation and biodiversity, outdoor sports and recreation and essential facilities such as changing rooms. Essential ancillary sleeping or residential accommodation for staff required by uses in this category, subject to a specific warning and evacuation plan.

Table 2.1 Development Types (Abstract)

	Flood	Flood Risk Vulnerability Classification				
	Zone	Essential Infrastructure	Highly Vulnerable	More Vulnerable	Less Vulnerable	Water Compatible
	I	✓	✓	✓	✓	✓
	2	✓	Exception Test	✓	✓	✓
	3a	Exception Test	х	Exception Test	✓	✓

Table 2.2 Flood Risk Classification

x

х

х

FLOOD ZONE COMPENSATION

3ь

Exception

Test

- 2.8. Proposed developments which are in Flood Zone 3 should not result in a net loss of flood storage capacity and where possible should seek to increase flood plain storage.
- 2.9. Therefore, to prevent significant losses in existing flood water storage and to assist any future compensation analysis. We would recommend that;
 - Proposed building footprints should be positioned within low risk areas such as Flood
 Zone I & 2 when possible.
 - Elements such as parking/service yards etc which are less sensitive to flood risk should be placed within the higher risk areas.

FLOOD ZONE REQUIREMENTS

- 2.10. Even though the development is at a preliminary stage the client and design team members should be mindful of the following items to alleviate/mitigate any issues during the later stages;
 - Finished Floor Levels
 - Flood Resistance
 - Flood Resilience
 - Safe Access and Egress Routes
 - Flood Flow/Routing
 - Sustainable Drainage Systems
 - Flood Warning and Evacuation Plans





SECTION 3 EXISTING DRAINAGE INFRASTRUCTURE

PUBLIC SEWERS

3.1. The public sewers in the area are owned and maintained by United Utilities (UU).
Their sewer records have been requested and have been included in Appendix C of this report.

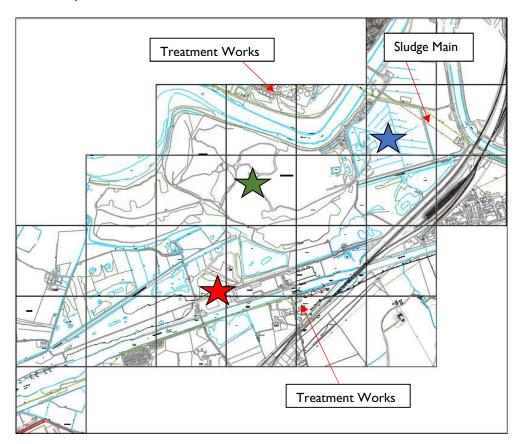


Figure 3.1 Combined UU Sewer Plan

Surface Water Sewers

3.2. United Utilities records do not identify any surface water sewers onsite or in the surround area. Surface water runoff from the existing developments likely discharge into the onsite waterbodies or adjacent MSC/River Mersey via a private network.

Foul Water Sewers

3.3. United Utilities records do not identify any foul water sewers onsite. Foul flows from the existing developments are likely treated onsite or discharges to either of the waste water treatment works (WWTW) via a private rising main.

Sudge Main/Rising Main

3.4. United Utilities records identify a 400mm sludge main (rising main) located along the north-eastern boundary (Arpley Meadows Business Park).



Combined Water Sewers

3.5. United Utilities records identifies a combined water sewer to the south of the MSC which discharges to the WWTW.

PRIVATE DRAINAGE

3.6. There are no known private drainage plans/records available.

PRELIMINARY DEVELOPMENT DRAINAGE

Surface Water Drainage

- 3.7. Based on the topography it should be possible to discharge any surface water runoff generated by the PDS to either the onsite waterbodies, MSC or River Mersey. This arrangement is in accordance with the runoff destination hierarchy set out in Paragraph 080 of the Flood Risk and Coastal Change Guidance document.
- 3.8. Note that any surface water runoff rates must be agreed by the Environment Agency and/or Lead Local Flood Authority. Greenfield runoff restrictions are likely to apply to the PDS.

Foul Water Drainage

- 3.9. Foul effluent generated by the PDS should discharge runoff to either of the nearby WWTW. If possible the PDS should utilise an existing route below the MSC if possible but would require further investigation.
- 3.10. At the stage the need for any off-site reinforcement is unknown and United Utilities should be consulted as soon as practically possible.

Sewer Diversions

3.11. No sewers identified onsite.



SECTION 4 UTILITIES INFRASTRUCTURE

ELECTRICITY

- 4.1. Scottish Power Manweb (SP Manweb) supplies the electricity in the area. Their asset records identify underground and over ground HV cables serving the existing Port developments and a 33kv cable serving the land fill development.
- 4.2. Note that there are overhead cables/pylons passing next to the proposed Arpley Meadows Business Park.

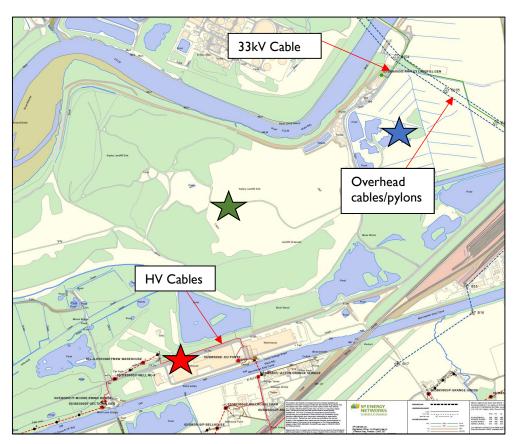


Figure 4.1 Electricity Infrastructure (SP Manweb)

- 4.3. The need for any offsite reinforcement to meet the supply/demand of the PDS is currently unknown. Discussions with SP Manweb should be undertaken as soon as practically possible.
- 4.4. A copy of SP Manweb's asset records is included in **Appendix D**.

TELECOMMUNICATION

4.5. Openreach records identify many over ground and underground services serving the existing Port and Landfill developments.



- 4.6. New supplies for the PDS could be taken from the existing infrastructure but it is unknown if there is sufficient capacity at this stage. Discussions with Openreach should be undertaken as soon as practically possible.
- 4.7. A copy of Openreach records has been included within **Appendix E**.

MAINS WATER

4.8. Watermain records have been requested from United Utilities and have been included within **Appendix F**. The records identify a public watermain serving the existing port which is then likely distributed to the units via a private network.

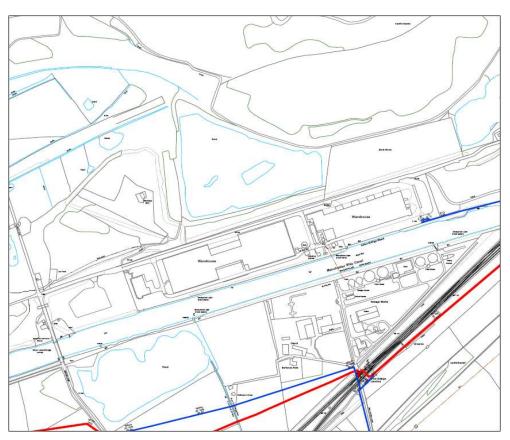


Figure 4.2 UU Watermain Records (South)

- 4.9. The records for the northern section of the PDS (Arply Meadows) does not indicate any public supplies onsite. The detail of the records is fuzzy but it does appear that there is a private main feeding the northern section of the site via a bridge crossing.
- 4.10. The need for any offsite reinforcement to meet the supply/demand of the PDS is currently unknown. Discussions with United Utilities should be undertaken as soon as practically possible.



Figure 4.3 UU Watermain Records (North)

GAS

- 4.11. Cadent/National Grid records identify Local High-Pressure main (LHP) along the eastern border of the PDS. The quality of the records has unfortunately limited the amount of information available such as size and depth.
- 4.12. Note that there may be legal easements associated with the LHP mains onsite and that specific offsets could be required for any proposed works i.e. piling.
- 4.13. The need for any offsite reinforcement to meet the supply/demand of the PDS is currently unknown. Discussions with Cadent/National Grid should be undertaken as soon as practically possible.

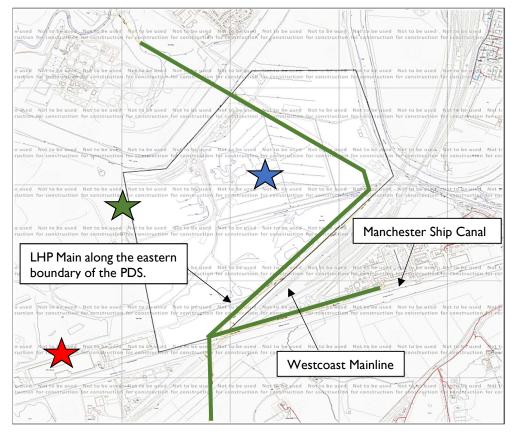


Figure 4.4 Cadent Gas Record Plans

4.14. A copy of Cadent/National Grid records has been included within **Appendix G**.



SECTION 5 HARAZARDOUS INSTALLATIONS & SERVICES

WARRINGTON PLANNING ADVICE

- 5.1. Warrington Borough Council provide a planning advice service which combines all known planning constraints onto ordnance survey maps. The map in **Figure 5.1** has been copied from their mapping service and identifies the known hazardous pipelines and installation around the PDS.
- 5.2. The service unfortunately, doesn't provide any further information beyond the zoning.

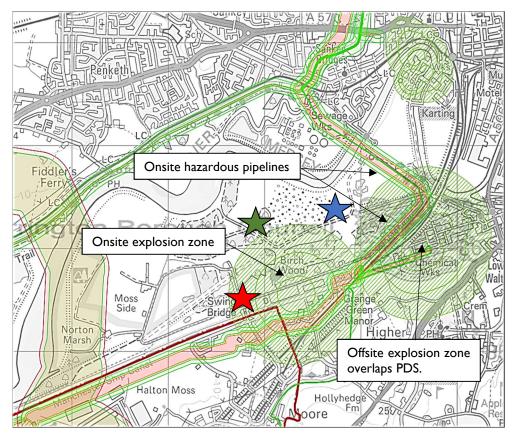


Figure 5.1 Warrington Planning Advice Map

HEALTH AND SAFETY EXECUTIVE CHECK

- 5.3. A preliminary consultation with the Health and Safety Executive website has identified the same hazardous installations and pipelines as shown in **Figure 5.1**. Copies of the HSE plans have been included within **Appendix H**.
- 5.4. The HSE website does not identify the owners of the explosive installations but has identified the pipeline owners a;
 - Sabic UK Petro Chemicals Ltd
 - Cadent Gas Limited Refer to **Section 4**



HSE Consultation Distances

- 5.5. The HSE plans provide consultation distances which consists of three zones; Inner, Middle and Outer. The zones are an offset distance from the hazard based on the associated risk but are currently unknown at this stage.
- 5.6. The HSE Land Use Planning Methodology document ranks the level of sensitivity of any development. Warrington Waterfronts intended development uses are classified as Level I to 3 depending upon the number of occupants;

Development Type	Examples	Development Detail and Size	Justification	
	Offices, factories, warehouses, haulage depots, farm buildings, non-retail markets, builders yard	Workplaces (predominantly non- retail) providing less than 100 occupants in each building and less than 3 occupied storeys – Level I	Places where the occupant will be fit and healthy, and could be organised easily for emergency action. Members of the public will not be present or will be present in very small numbers for a brief time.	
	Exclusions			
DT1.1 Workplaces	Sheltered workshops, reemploy	Workplaces (predominantly non- retail) providing less than 100 occupants in each building and less than 3 occupied storeys – Level 2 (Except where the development is at the major hazard site itself, where it remains Level 1)	Substantial increase in the numbers at risk with no direct benefit from exposure to the risk	
		DTI.2 x I Workplaces (predominantly non- retail) specifically for people with disabilities - Level 3	Those at risk may be especially vulnerable to injury from hazardous events and / or they may not be able to be organised easily for emergency action.	

Table 5.1 HSE Development Classification - Workplace

5.7. **Table 5.1** classifies non-retail workplaces with less than 100 occupants in each building (less than 3 storeys) is Level 1. This classification will likely apply to most of the developments on the PDS.

	Examples	Development Detail and Size	Justification	
	Motorway, dual carriageway	Major transport links in their own right i.e. not as integral part of other developments – Level 2	Prime purpose is as a transport link. Potentially large numbers exposed to risk, but exposure of an individual is only for a brief period.	
	Exclusions			
DT2.3 Transport Links	Estate roads, access roads,	DT2.3 x I Single carriageway roads – Level I	Minimal numbers present and mostly a small period of time exposed to risk. Associated with other development	
	Any railway or tram	DT2.3 x 2 Railways – Level I	Transient population small period of time exposed to risk. Periods of time with no population present.	

Table 5.2 HSE Development Classification - Transport

- 5.8. Table 5.2 classifies the proposed site infrastructure (access road and railway connection) to the PDS as Level 1.
- 5.9. Table 5.3 indicates that proposed development types with a Level I sensitivity can be placed within any of the HSE Consultation Zones.

Level of Sensitivity	Developments in Inner Zone	Development in Middle Zone	Development in Outer Zone
I	Don't Advise Against	Don't Advise Against	Don't Advise Against
2	Advise Against	Don't Advise Against	Don't Advise Against
3	Advise Against	Advise Against	Don't Advise Against
4	Advise Against	Advise Against	Advise Against

Table 5.3 HSE Decision Matrix

SABIC UK PETRO CHEMICALS LTD

- 5.10. Saudi Basic Industries Corporation (SABIC) records have been included within Appendix I and identifies the onsite pipelines as;
 - 8" High Pressure Ethylene pipe
 - INEOS Hydrogen pipe.


Figure 5.2 SABIC Infrastructure




SECTION 6 CONCLUSION

- 6.1. This preliminary planning advice statement provides an overview of the existing infrastructure on or around the proposed site and evaluates flood risk issues that may potentially influence the conceptual masterplan. In summary, the statement confirms that;
 - a) That the proposed development site is within Flood Zone I, 2 & 3 (low, medium and high probability). In accordance with the Flood Risk and Coastal Change Guidance the proposed land uses are acceptable in these zones.
 - b) The proposed surface water runoff generated by the proposals should discharge to the onsite waterbodies and/or the Manchester Ship Canal/River Mersey. Flow rates are to be agreed with the Environment Agency, Manchester Ship Canal or Lead Local Flood Authority (depending on waterbody).
 - c) The proposed foul water effluent should discharge to either of the nearby Waste Water Treatment Works. The flow rates and need for any offsite/onsite upgrade works are to be agreed with United Utilities.
 - d) Early discussions with Electricity North West are required to establish the proposed electricity supply/route(s) to the site.
 - e) The existing Openreach infrastructure onsite should be able to cater for the site proposals. But early discussions with Openreach should be undertaken.
 - f) Early discussions with United Utilities are required to establish the proposed mains water route(s) to the site.
 - g) Early discussions with Cadent/National Grid are required to confirm the onsite easement associated with the LHP main and establish the future proposed gas main route(s) to the site (if required).
 - h) Early discussions with Health and Safety Executive are required to confirm the consulting distances associated with the LHP and SABIC pipelines as well as the two industrial units. Once confirmed the conceptual masterplan can be approved in principal by the HSE to avoid any future objections during the planning process.

APPENDIX A

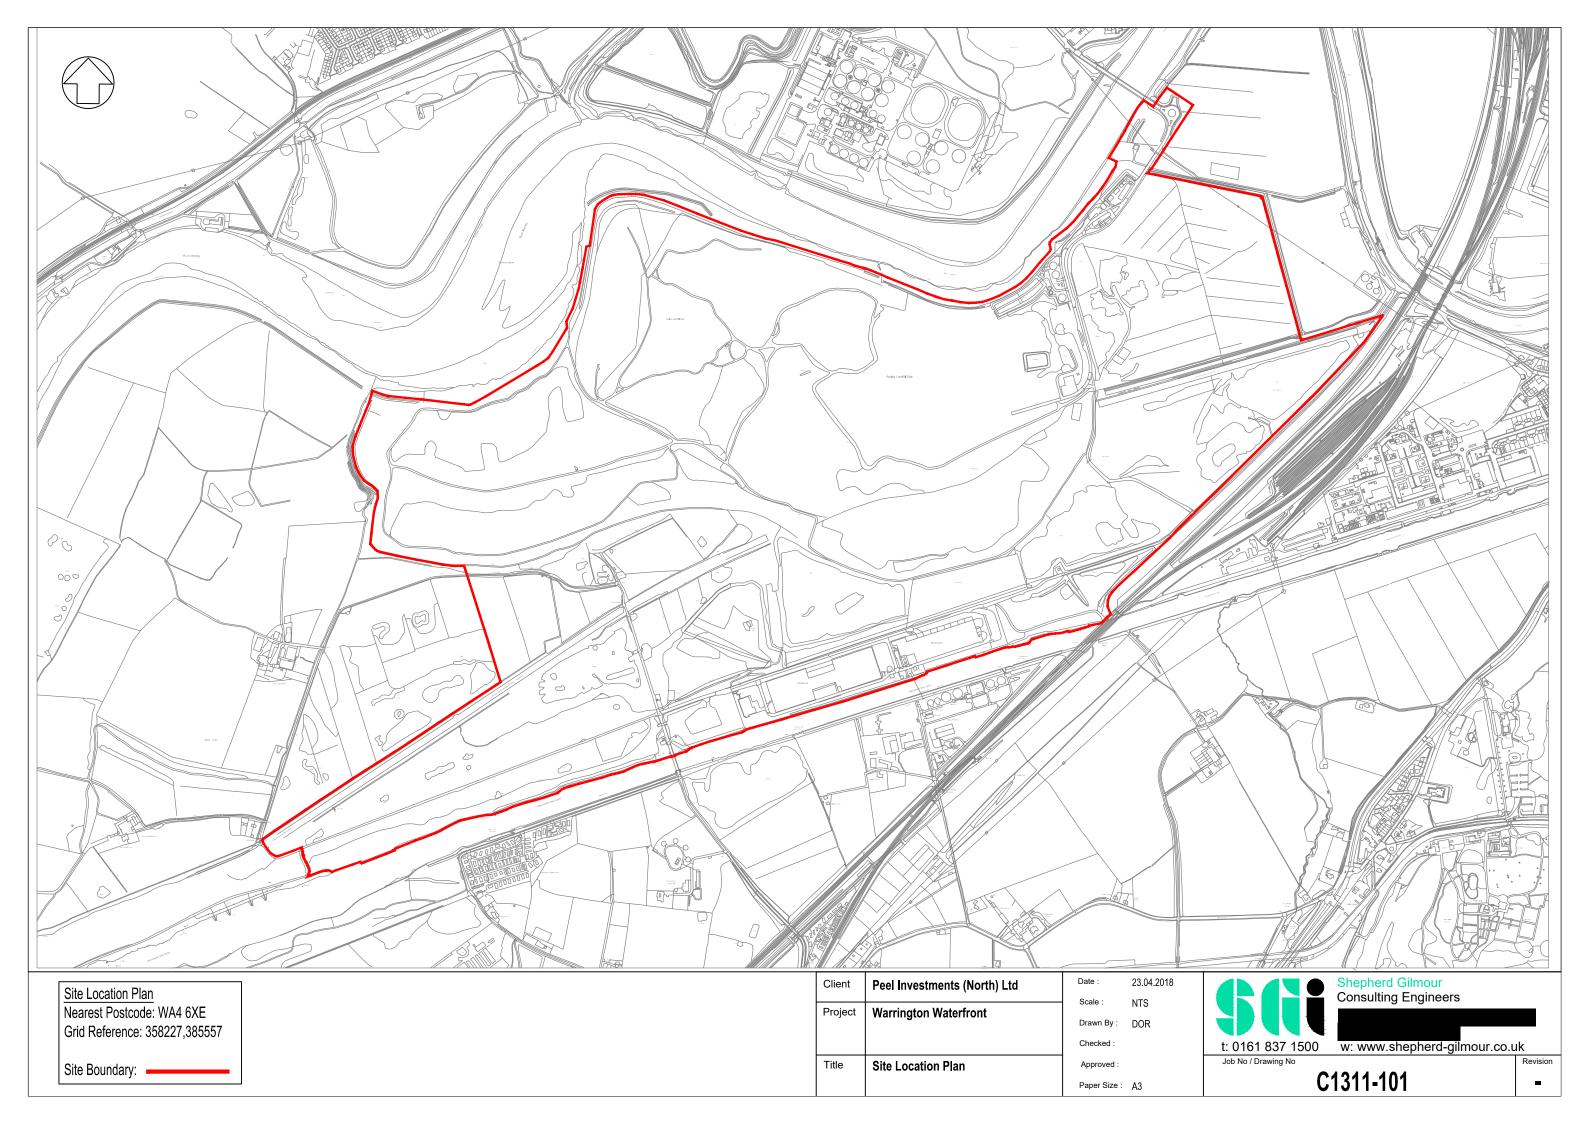

APPENDIX B

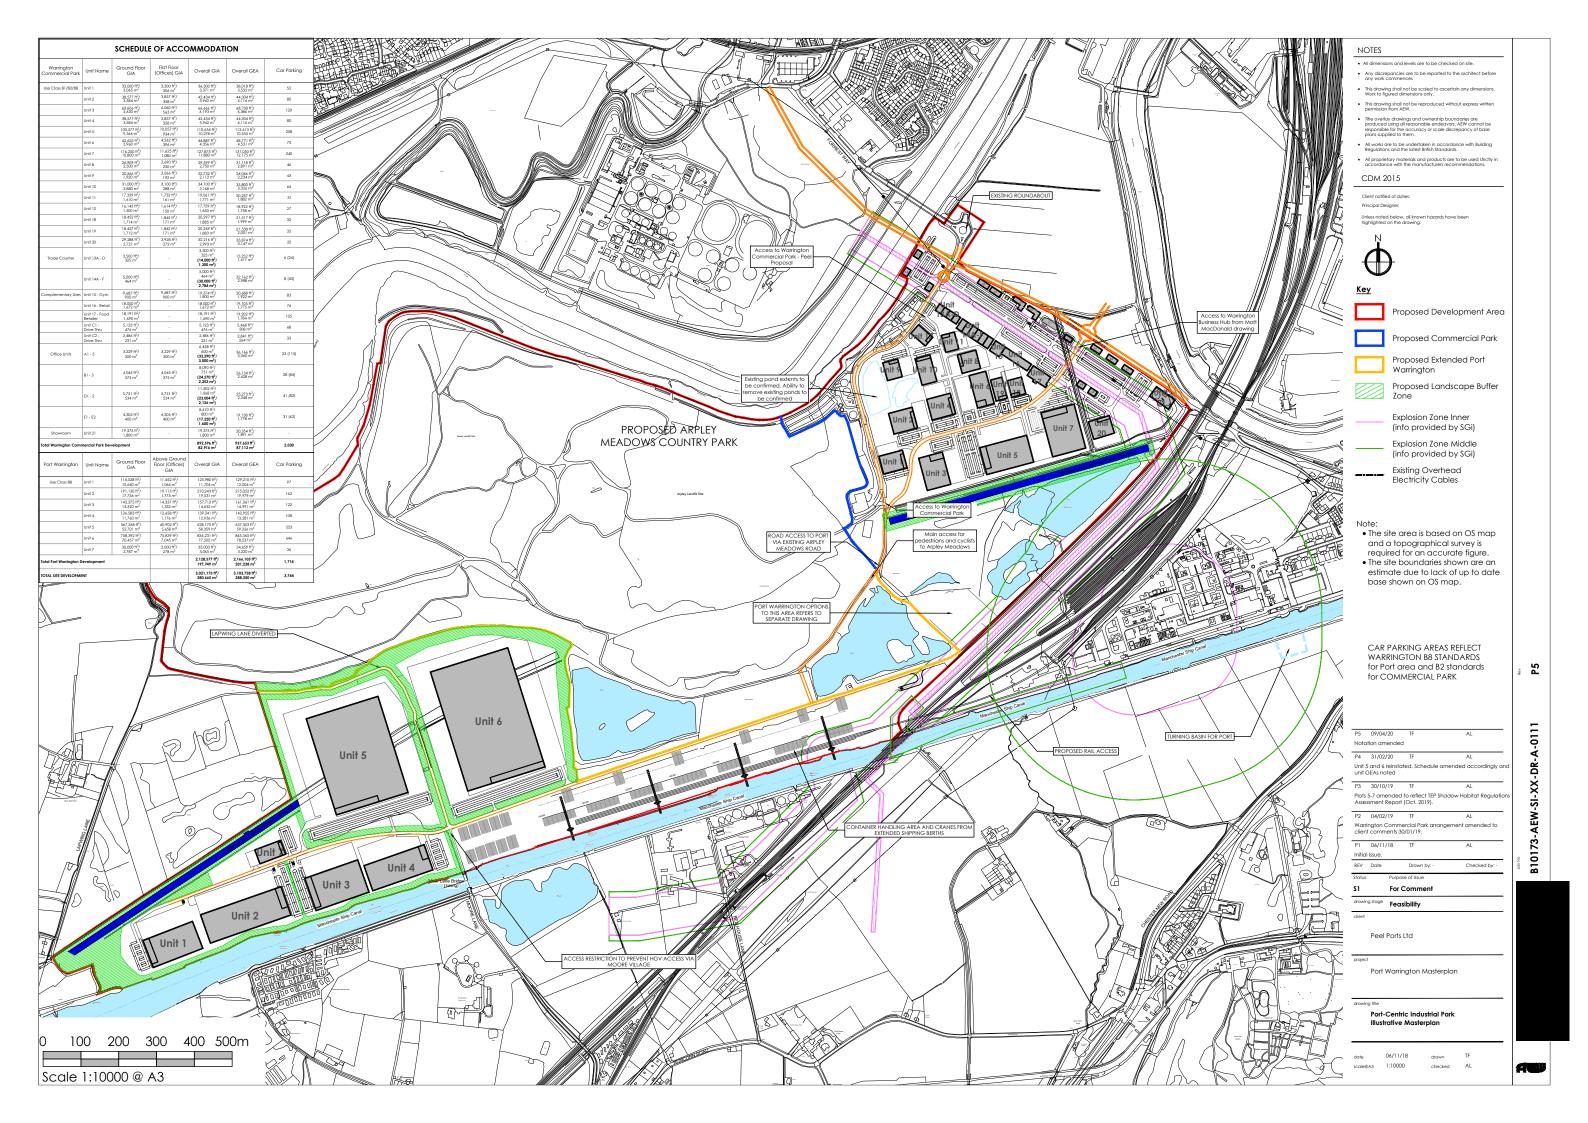

APPENDIX C



SGi Consulting

FAO:

How to contact us:

Telephone:

Your Ref: Warrington40 Our Ref: UUPS-ORD-18075

Date: 22/03/2018

E-mail:

Dear Sirs

Location: Port Warrington

I acknowledge with thanks your request dated 15/03/2018 for information on the location of our services.

Please find enclosed plans showing the approximate position of United Utilities' apparatus known to be in the vicinity of this site.

The enclosed plans are being provided to you subject to the United Utilities terms and conditions for both the wastewater and water distribution plans which are shown attached.

If you are planning works anywhere in the North West, please read United Utilities' access statement before you start work to check how it will affect our network. http://www.unitedutilities.com/work-near-asset.aspx.

I trust the above meets with your requirements and look forward to hearing from you should you need anything further.

If you have any queries regarding this matter please contact us.

Yours Faithfully,






TERMS AND CONDITIONS - WASTERWATER AND WATER DISTRIBUTION PLANS

These provisions apply to the public sewerage, water distribution and telemetry systems (including sewers which are the subject of an agreement under Section 104 of the Water Industry Act 1991 and mains installed in accordance with the agreement for the self construction of water mains) (UUWL apparatus) of United Utilities Water Limited "(UUWL)".

TERMS AND CONDITIONS:

- This Map and any information supplied with it is issued subject to the provisions contained below, to the exclusion of all others and no party relies upon any representation, warranty, collateral contract or other assurance of any person (whether party to this agreement or not) that is not set out in this agreement or the documents referred to in it.
- This Map and any information supplied with it is provided for general guidance only and no representation, undertaking or warranty as to its accuracy, completeness or being up to date is given or implied.
- In particular, the position and depth of any UUWL apparatus shown on the Map are approximate only. UUWL strongly recommends that a comprehensive survey is undertaken in addition to reviewing this Map to determine and ensure the precise location of any UUWL apparatus. The exact location, positions and depths should be obtained by excavation trial holes.
- The location and position of private drains, private sewers and service pipes to properties are not normally shown on this Map but their presence must be anticipated and accounted for and you are strongly advised to carry out your own further enquiries and investigations in order to locate the same.
- The position and depth of UUWL apparatus is subject to change and therefore this Map is issued subject to any removal or change in location of the same. The onus is entirely upon you to confirm whether any changes to the Map have been made subsequent to issue and prior to any works being carried out.
- This Map and any information shown on it or provided with it must not be relied upon in the event of any development, construction or other works (including but not limited to any excavations) in the vicinity of UUWL apparatus or for the purpose of determining the suitability of a point of connection to the sewerage or other distribution systems.
- No person or legal entity, including any company shall be relieved from any liability howsoever and whensoever arising for any damage caused to UUWL apparatus by reason of the actual position and/or depths of UUWL apparatus being different from those shown on the Map and any information supplied with it.
- If any provision contained herein is or becomes legally invalid or unenforceable, it will be taken to be severed from the remaining provisions which shall be unaffected and continue in full force and affect.
- This agreement shall be governed by English law and all parties submit to the exclusive jurisdiction of the English courts, save that nothing will prevent UUWL from bringing proceedings in any other competent jurisdiction, whether concurrently or otherwise.

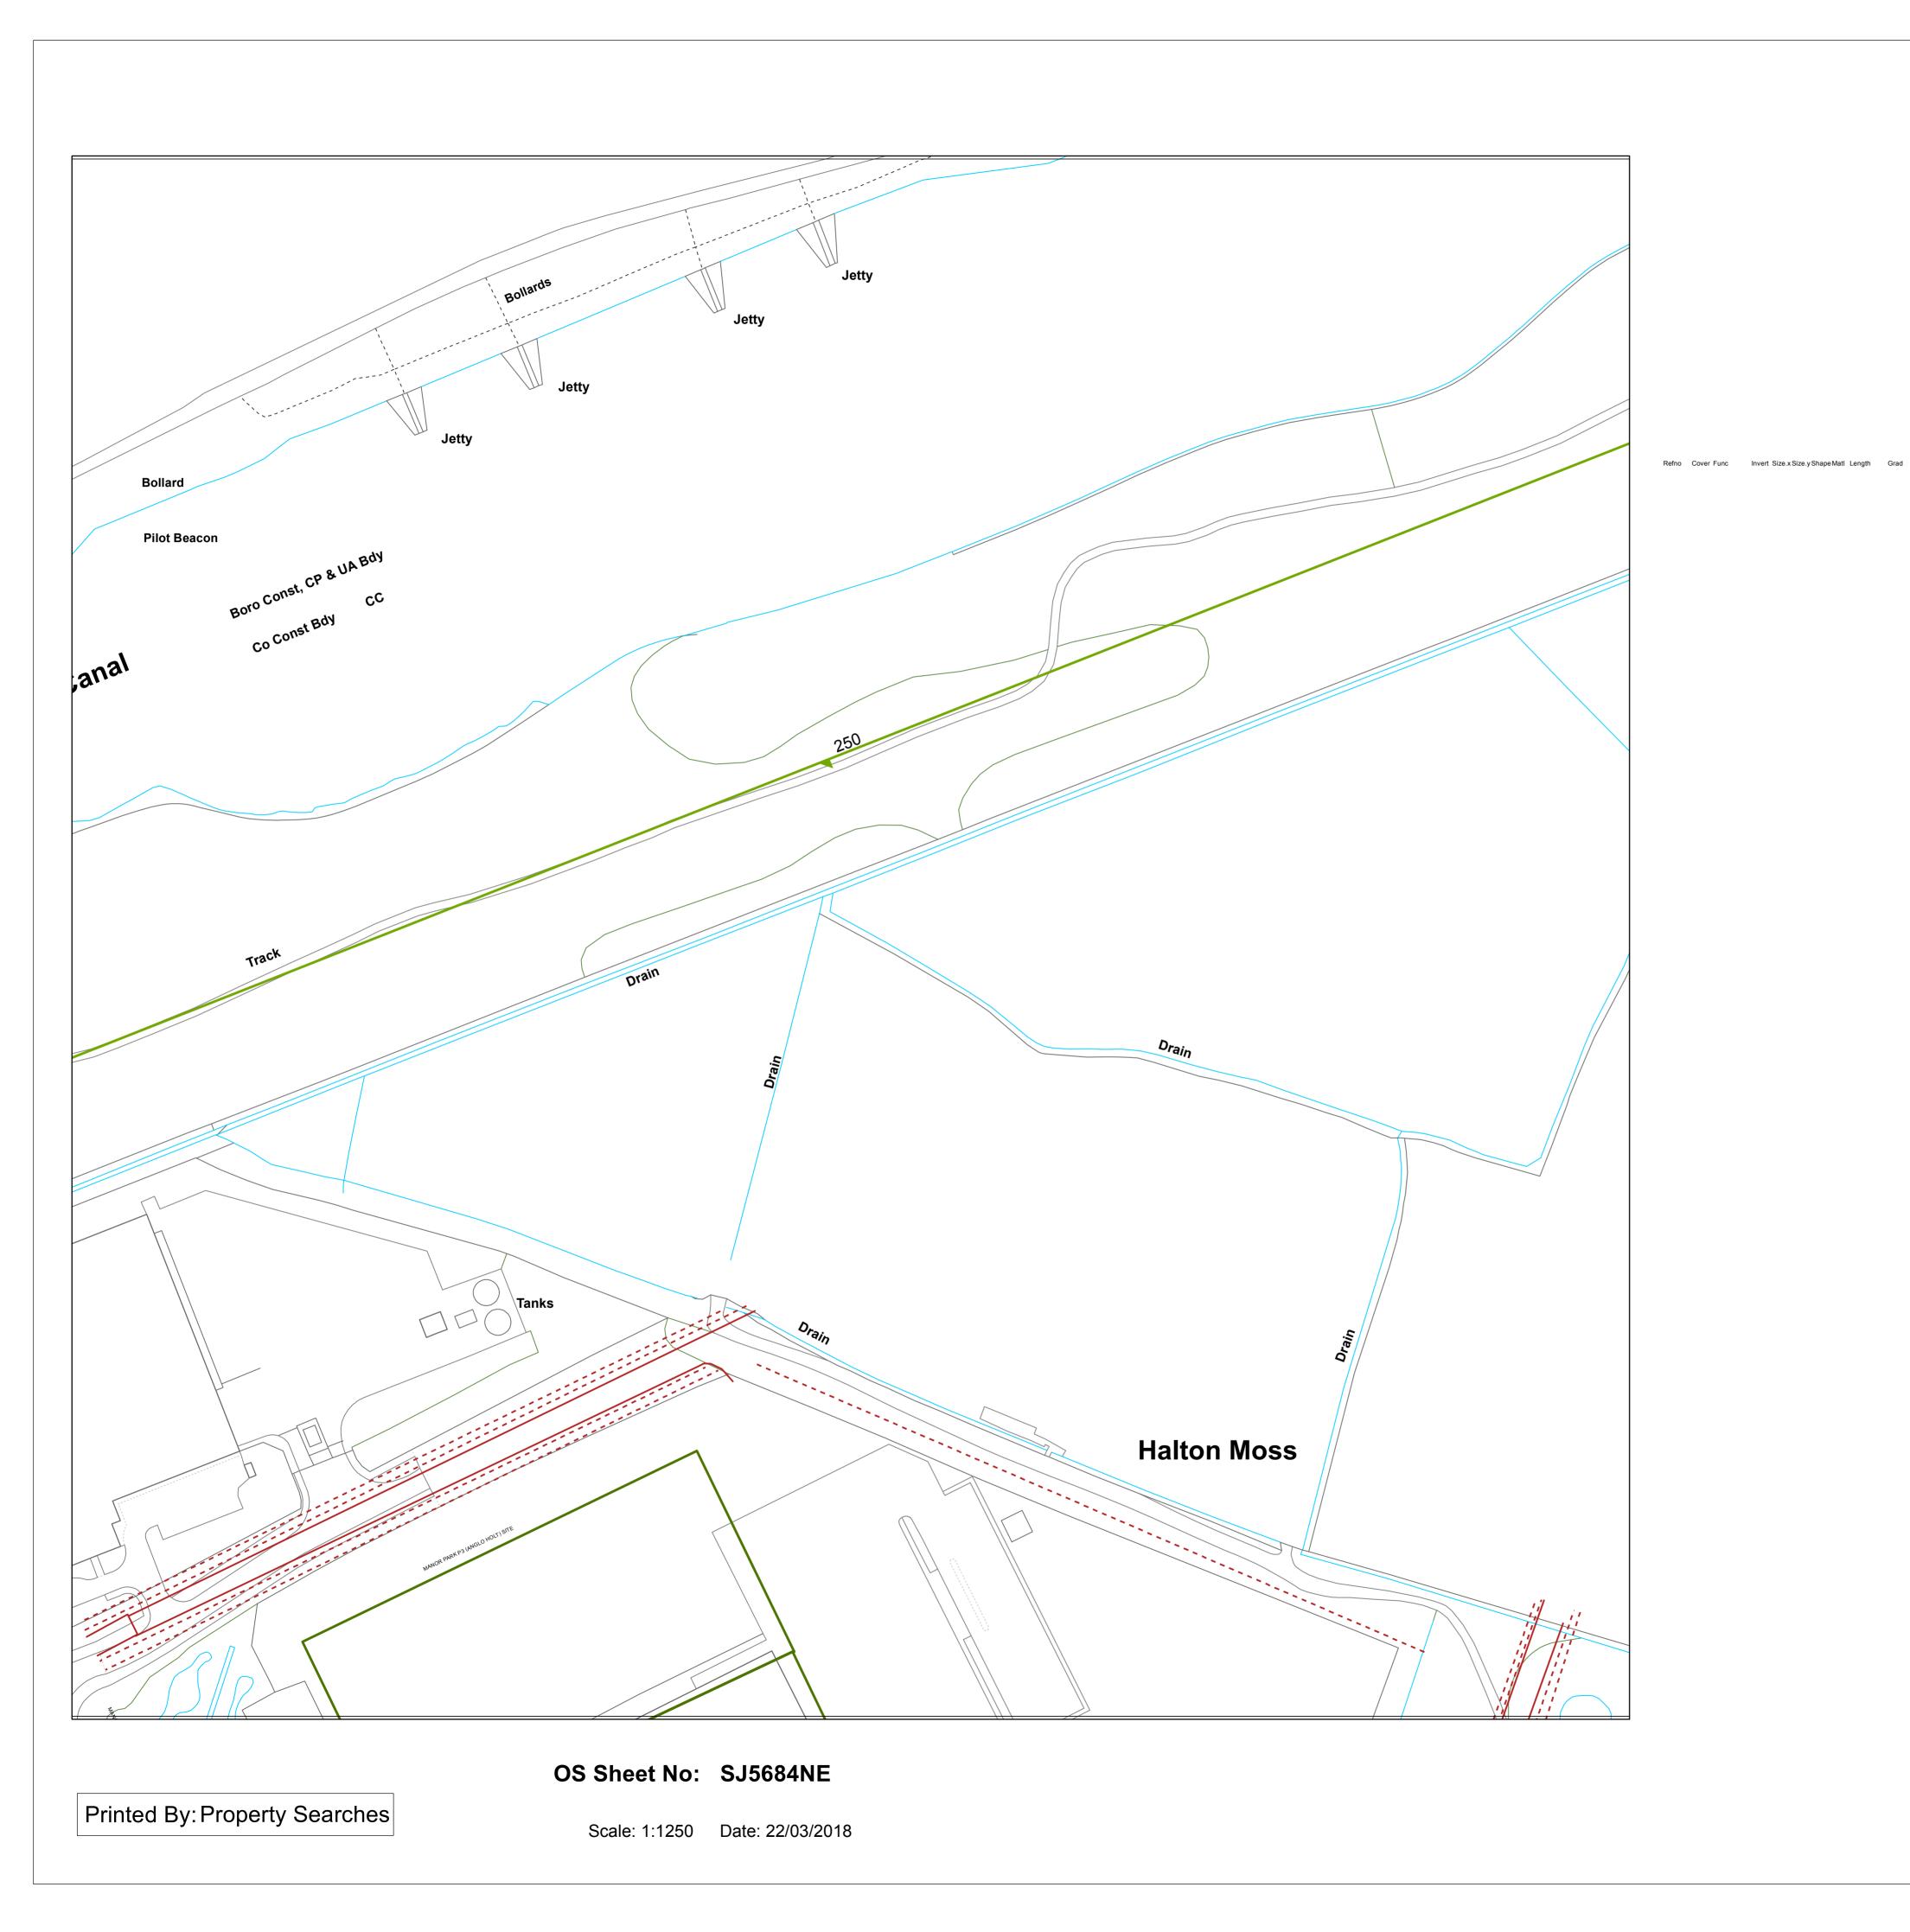

Surface Combined Overflow Highway Drain, Private Foul Surface Combined WW Site Termination Sludge Main, Public — 🛌 - Sludge Main, Private — ► – Sludge Main, S104 Non Return Valve **ABANDONED PIPE** Extent of Survey → MainSewer Rising Main → - - Highway Drain Sludge Main 🎳 Head of System ● Hydrobrake/Vortex Inspection Chamber Contaminated Surface Water WW Pumping Station Sludge Pumping Station → Sewer Overflow 🗂 🛱 🔼 TJunction/Saddle √alve Chamber Washout Chamber DropShaft WW Treatment Works Network Storage Tank 💞 🞳 💕 Orifice Plate Vortex Chamber Foul Surface Combined Overflow Screen Chamber CK Control Kiosk P Discharge Point Unspecified → ← → Outfall LEGEND MANHOLE FUNCTION FO Foul SW Surface Water CO Combined OV Overflow **SEWER SHAPE** CI Circular EG Egg OV Oval FT Flat Top RE Rectangular SQ Square DI Ductile Iron AC Asbestos Cement PVC Polyvinyl Chloride PE Polyethylene RP Reinforced Plastic Matrix CO Concrete CSB Concrete Segment Bolted CSU Concrete Segment Unbolted Pitch Fibre CC Concrete Box Culverted PSC Plastic/Steel Composite MAC Masonry, Coursed GRC Glass Reinforced Concrete MAR Masonry, Random GRP Glass Reinforced Plastic U Unspecified The position of the underground apparatus shown on this plan is approximate only and is given in accordance with the best information currently available. United Utilities Water will not accept liability for any loss or damage caused by the actual position being different from those shown. Crown copyright and database rights [2016] Ordnance Survey 100022432. OS Sheet No: SJ5684NE Scale: 1:1250 Date: 22/03/2018


WASTE WATER SYMBOLOGY

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0 Nodes Sheet 1 of 1



SEWER RECORDS

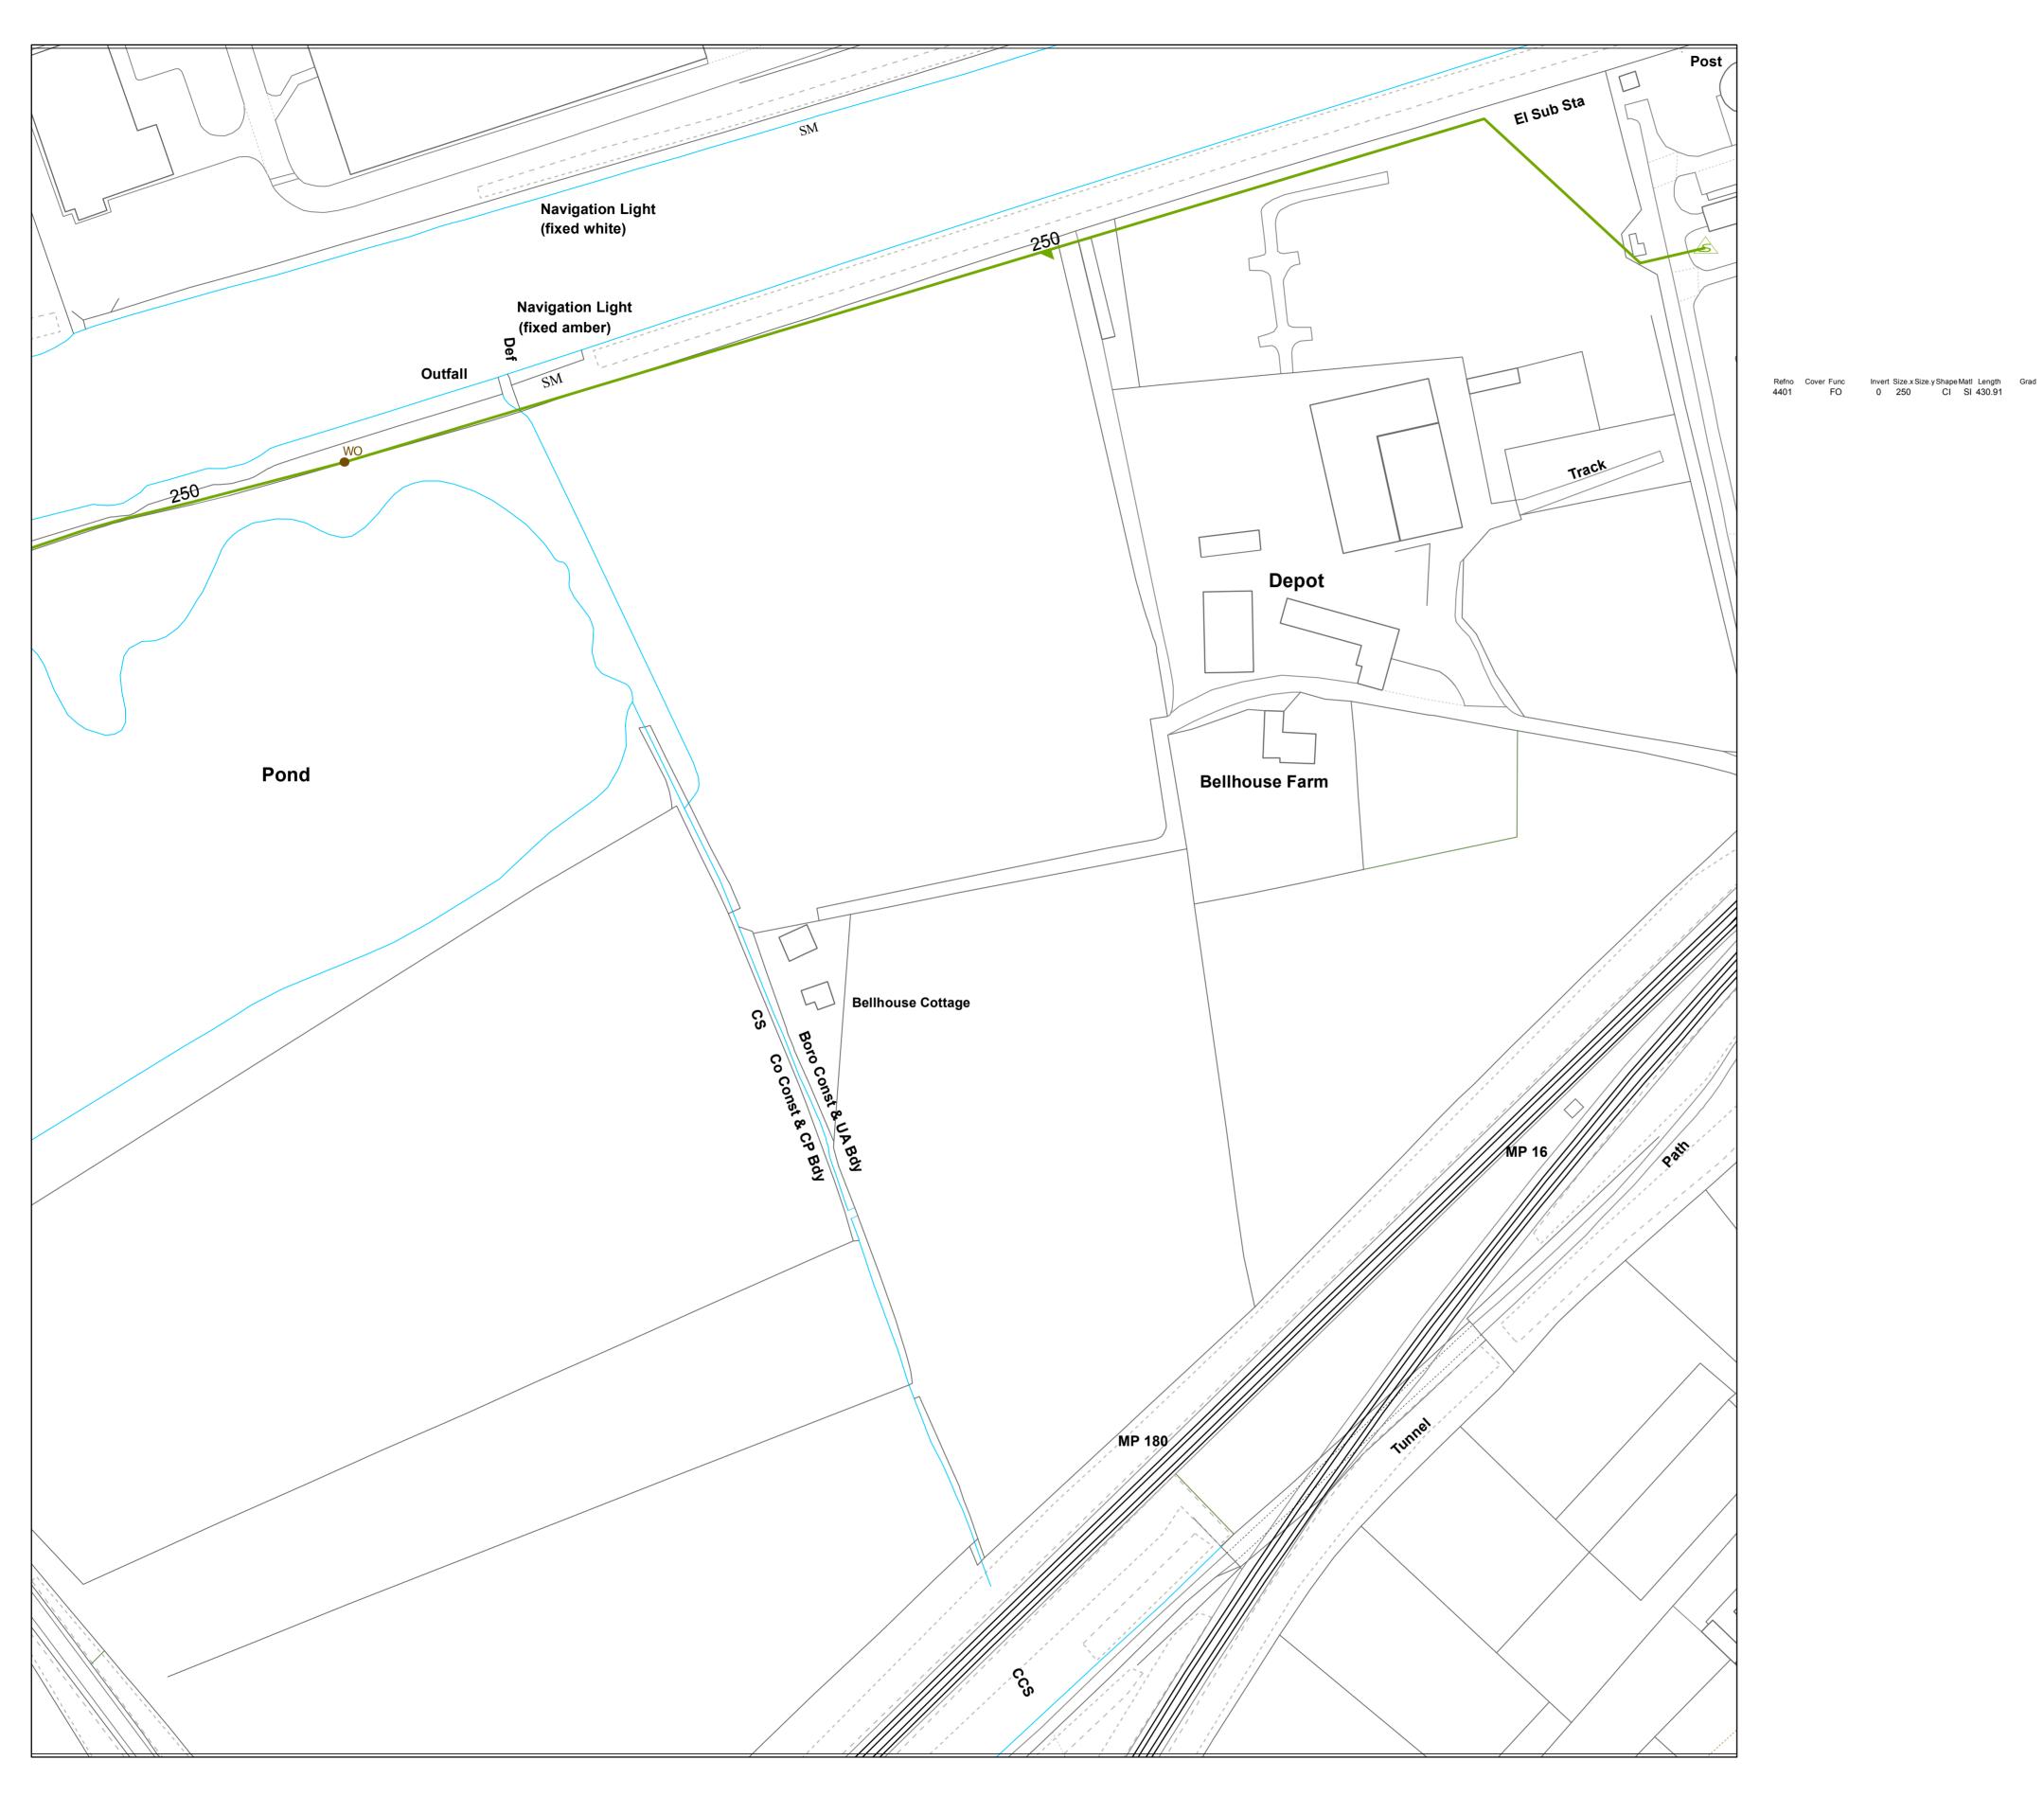

OS Sheet No: SJ5885SW

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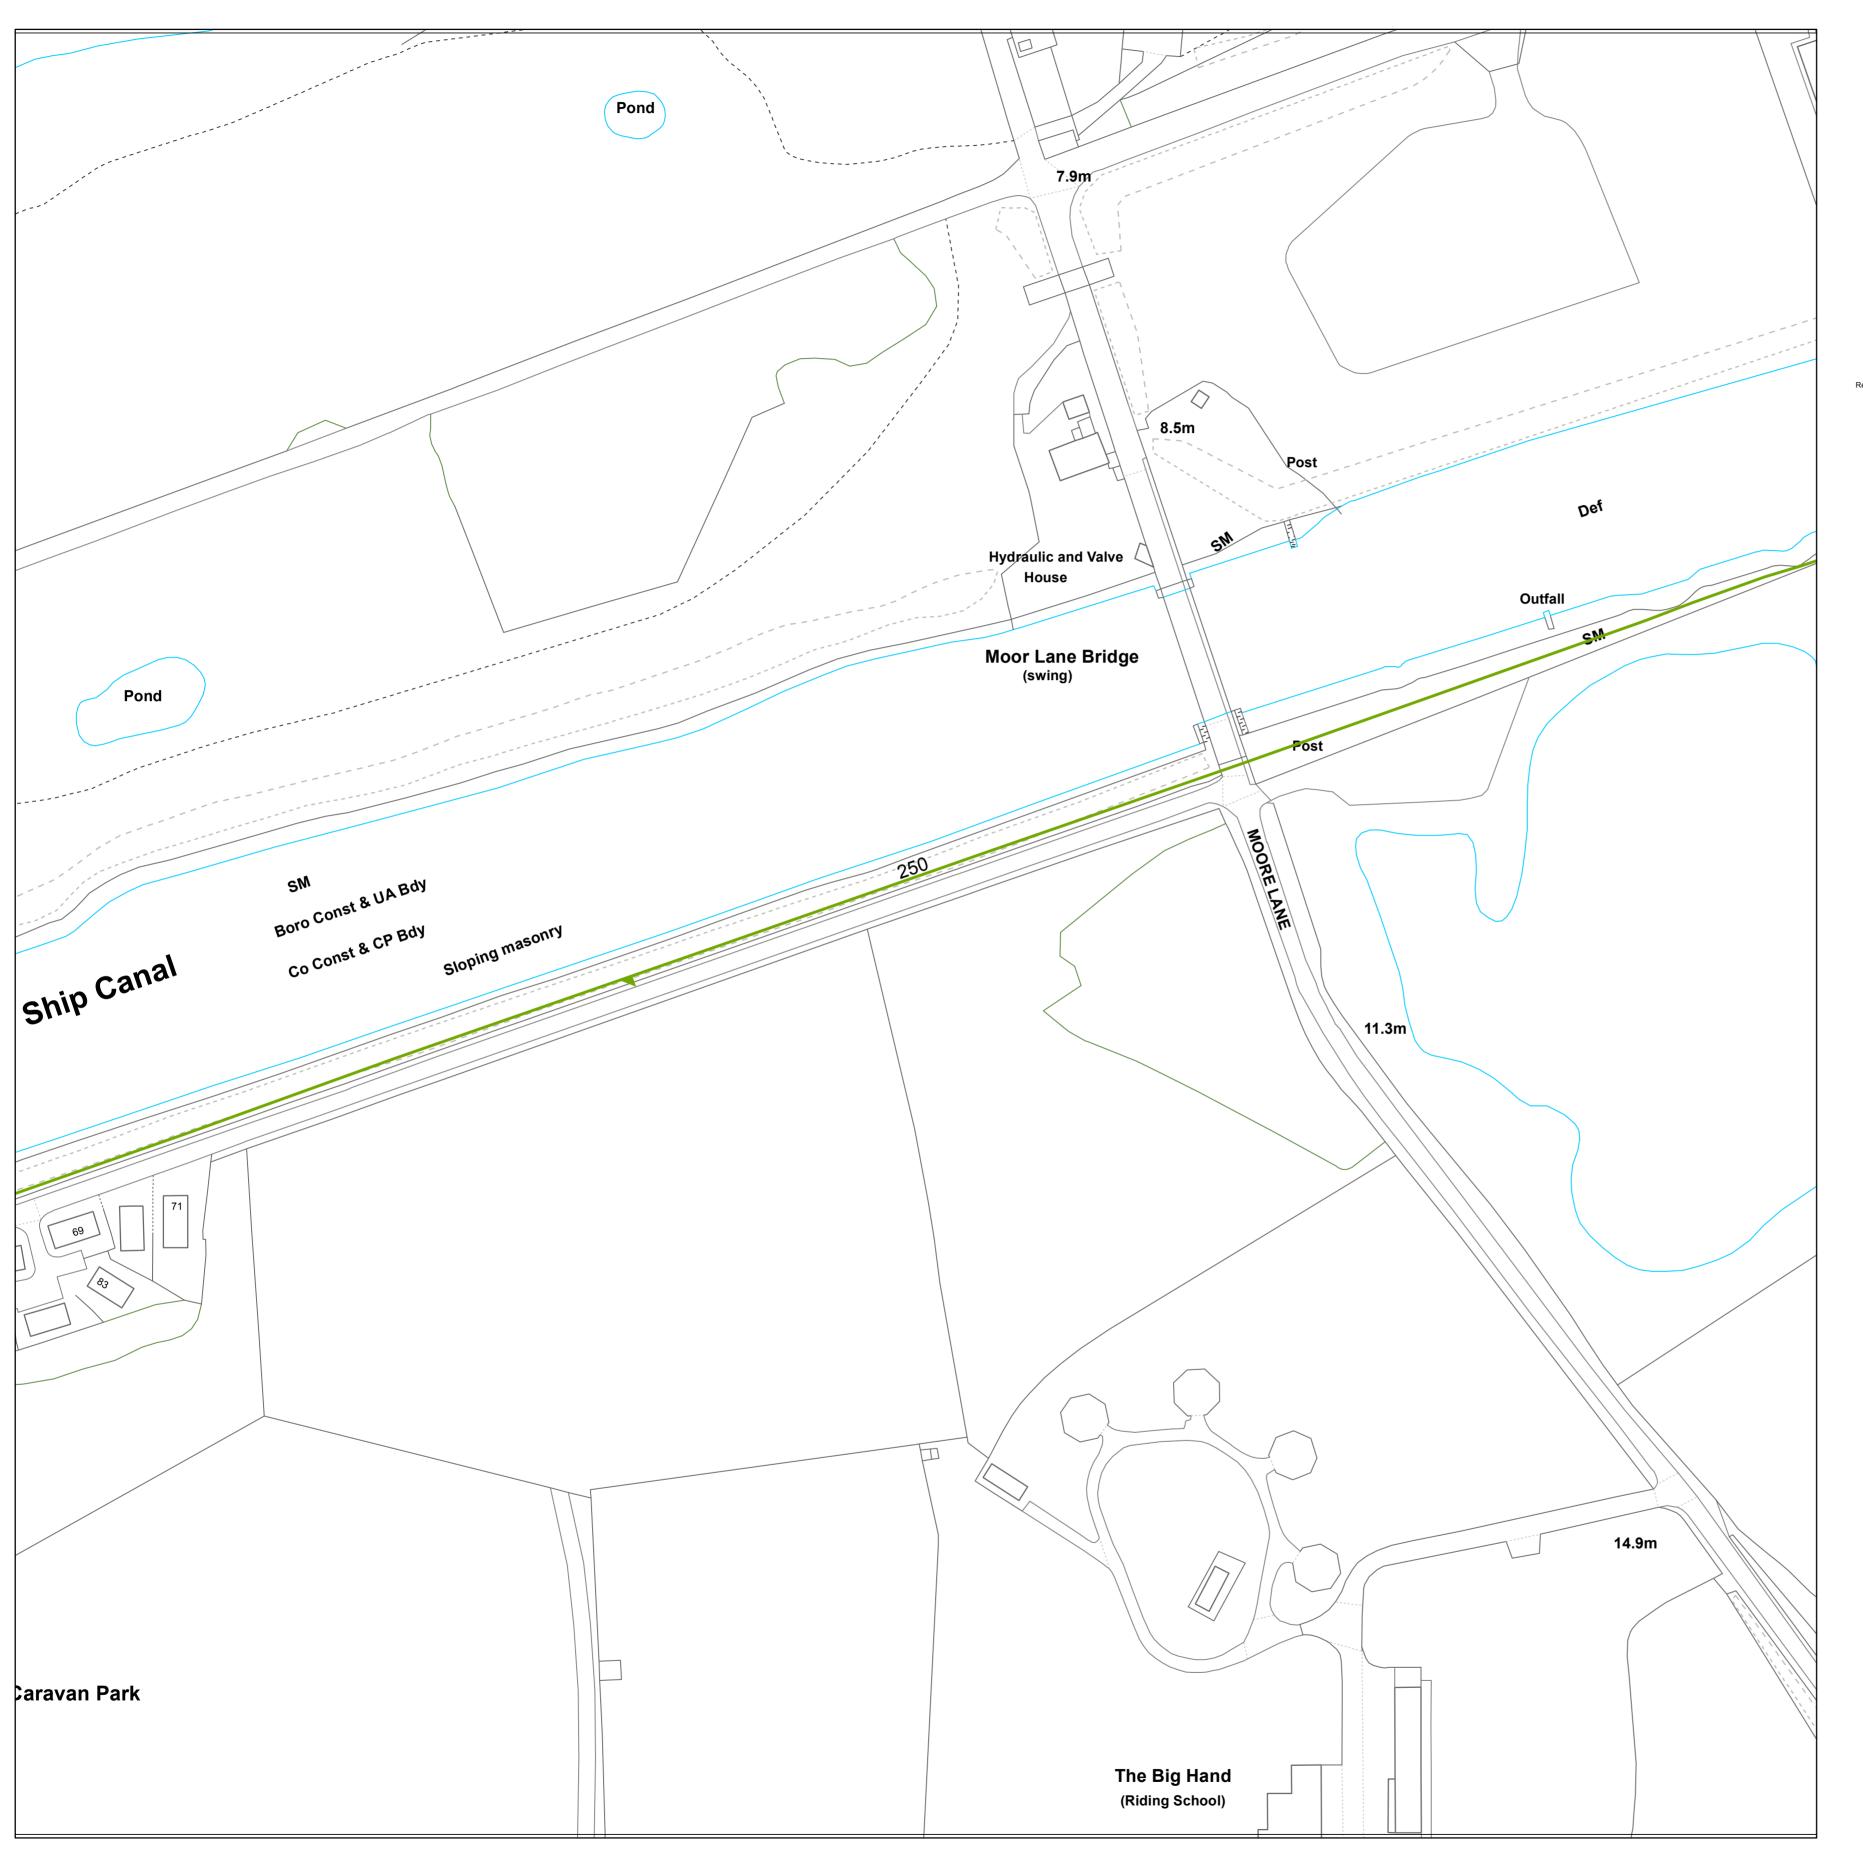
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WASTE WATER SYMBOLOGY Surface Combined Overflow — — — — — — — Rising Main, S104 Highway Drain, Private Foul Surface Combined WW Site Termination ——— Sludge Main, Public — 느 - Sludge Main, Private — ► – Sludge Main, S104 Non Return Valve **ABANDONED PIPE** Extent of Survey → MainSewer Rising Main → - - Highway Drain Sludge Main Head of System ● Hydrobrake/Vortex Inspection Chamber Contaminated Surface Water WW Pumping Station Sludge Pumping Station → i→ Sewer Overflow 🗂 🛱 🔼 TJunction/Saddle OilInterceptor √c ∨alve Chamber Washout Chamber WW Treatment Works Septic Tank Network Storage Tank 🔐 🔐 💕 Orifice Plate Vortex Chamber Foul Surface Combined Overflow Screen Chamber CK Control Kiosk P Discharge Point Unspecified → ← → Outfall **LEGEND** MANHOLE FUNCTION FO Foul SW Surface Water CO Combined OV Overflow SEWER SHAPE CI Circular TR Trapezoidal EG Egg OV Oval FT Flat Top RE Rectangular SQ Square DI Ductile Iron AC Asbestos Cement PVC Polyvinyl Chloride PE Polyethylene RP Reinforced Plastic Matrix CO Concrete CSB Concrete Segment Bolted CSU Concrete Segment Unbolted Pitch Fibre CC Concrete Box Culverted PSC Plastic/Steel Composite MAC Masonry, Coursed GRC Glass Reinforced Concrete MAR Masonry, Random GRP Glass Reinforced Plastic U Unspecified The position of the underground apparatus shown on this plan is approximate only and is given in accordance with the best information currently available. United Utilities Water will not accept liability for any loss or damage caused by the actual position being different from those shown. Crown copyright and database rights [2016] Ordnance Survey 100022432. OS Sheet No: SJ5885SW Scale: 1:1250 Date: 22/03/2018 1 Nodes Sheet 1 of 1

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SEWER RECORDS



Refno Cover Func Invert Size.x Size.y Shape Matl Length Grad Refno Cover Func Invert Size.x Size.y Shape Matl Length Grad

GRC Glass Reinforced Concrete MAR Masonry, Random

GRP Glass Reinforced Plastic U Unspecified

The position of the underground apparatus shown on this plan is approximate only and is given in accordance with the best information currently available. United Utilities Water will not accept liability for any loss or damage caused by the actual position being different from those shown. Crown copyright and database rights [2016] Ordnance Survey 100022432.

DI Ductile Iron

PF Pitch Fibre

MAC Masonry, Coursed

PVC Polyvinyl Chloride

WASTE WATER SYMBOLOGY

Foul Surface Combined

Surface Combined Overflow

Extent of Survey

● Hydrobrake / Vortex

WW Pumping Station

→ Sewer Overflow

vc Valve Chamber

WW Treatment Works

Network Storage Tank

LEGEND

Orifice Plate Vortex Chamber

TR Trapezoidal

Washout Chamber

Screen Chamber

P Discharge Point

→ ← → Outfall

MANHOLE FUNCTION

SW Surface Water
CO Combined
OV Overflow
SEWER SHAPE
CI Circular

AC Asbestos Cement

RP Reinforced Plastic Matrix

CSB Concrete Segment Bolted
CSU Concrete Segment Unbolted

CC Concrete Box Culverted
PSC Plastic/Steel Composite

PE Polyethylene

CO Concrete

FO Foul

EG Egg
OV Oval
FT Flat Top
RE Rectangular
SQ Square
SEWER MATERIAL

Foul Surface Combined Overflow

Inspection Chamber

Contaminated Surface Water

Sludge Pumping Station

Highway Drain, Private

ABANDONED PIPE

→ MainSewer
→ Rising Main
→ Highway Drain
→ Sludge Main

Sludge Main, Public
Sludge Main, Private
Sludge Main, S104

Unspecified

OS Sheet No: SJ5785SE

Scale: 1:1250 Date: 22/03/2018

0 Nodes

Sheet 1 of 1



SEWER RECORDS

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— Mules — Mules — Mules Rising Main, S104 Foul Surface Combined WW Site Termination Non Return Valve Extent of Survey Head of System Refno Cover Func Invert Size.xSize.yShapeMatl Length Grad ● Hydrobrake/Vortex Inspection Chamber Contaminated Surface Water WW Pumping Station Sludge Pumping Station → i→ Sewer Overflow 🛱 🛱 🔼 T Junction/Saddle √alve Chamber ● Washout Chamber WW Treatment Works Septic Tank Network Storage Tank 🔐 🔐 💕 Orifice Plate O O O Vortex Chamber Foul Surface Combined Overflow P Discharge Point → ← → Outfall MANHOLE FUNCTION FO Foul SW Surface Water CO Combined OV Overflow SEWER SHAPE CI Circular EG Egg OV Oval RE Rectangular SQ Square AC Asbestos Cement PE Polyethylene RP Reinforced Plastic Matrix CO Concrete CSB Concrete Segment Bolted CSU Concrete Segment Unbolted CC Concrete Box Culverted

WASTE WATER SYMBOLOGY

Surface Combined Overflow

Highway Drain, Private

ABANDONED PIPE

→ MainSewer Rising Main → - - Highway Drain Sludge Main

——— Sludge Main, Public — 느 - Sludge Main, Private — 🛰 — Sludge Main, S104

CK Control Kiosk

Unspecified

GRP Glass Reinforced Plastic U Unspecified The position of the underground apparatus shown on this plan is approximate only and is given in accordance with the best information currently available. United Utilities Water will not accept liability for any loss or damage caused by the actual position being different from those shown. Crown copyright and database rights [2016] Ordnance Survey 100022432.

PSC Plastic/Steel Composite

GRC Glass Reinforced Concrete

DI Ductile Iron

PVC Polyvinyl Chloride

MAC Masonry, Coursed

MAR Masonry, Random

LEGEND

OS Sheet No: SJ5785SW Scale: 1:1250 Date: 22/03/2018

> 0 Nodes Sheet 1 of 1




SEWER RECORDS

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GRP Glass Reinforced Plastic U Unspecified

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DI Ductile Iron

PVC Polyvinyl Chloride

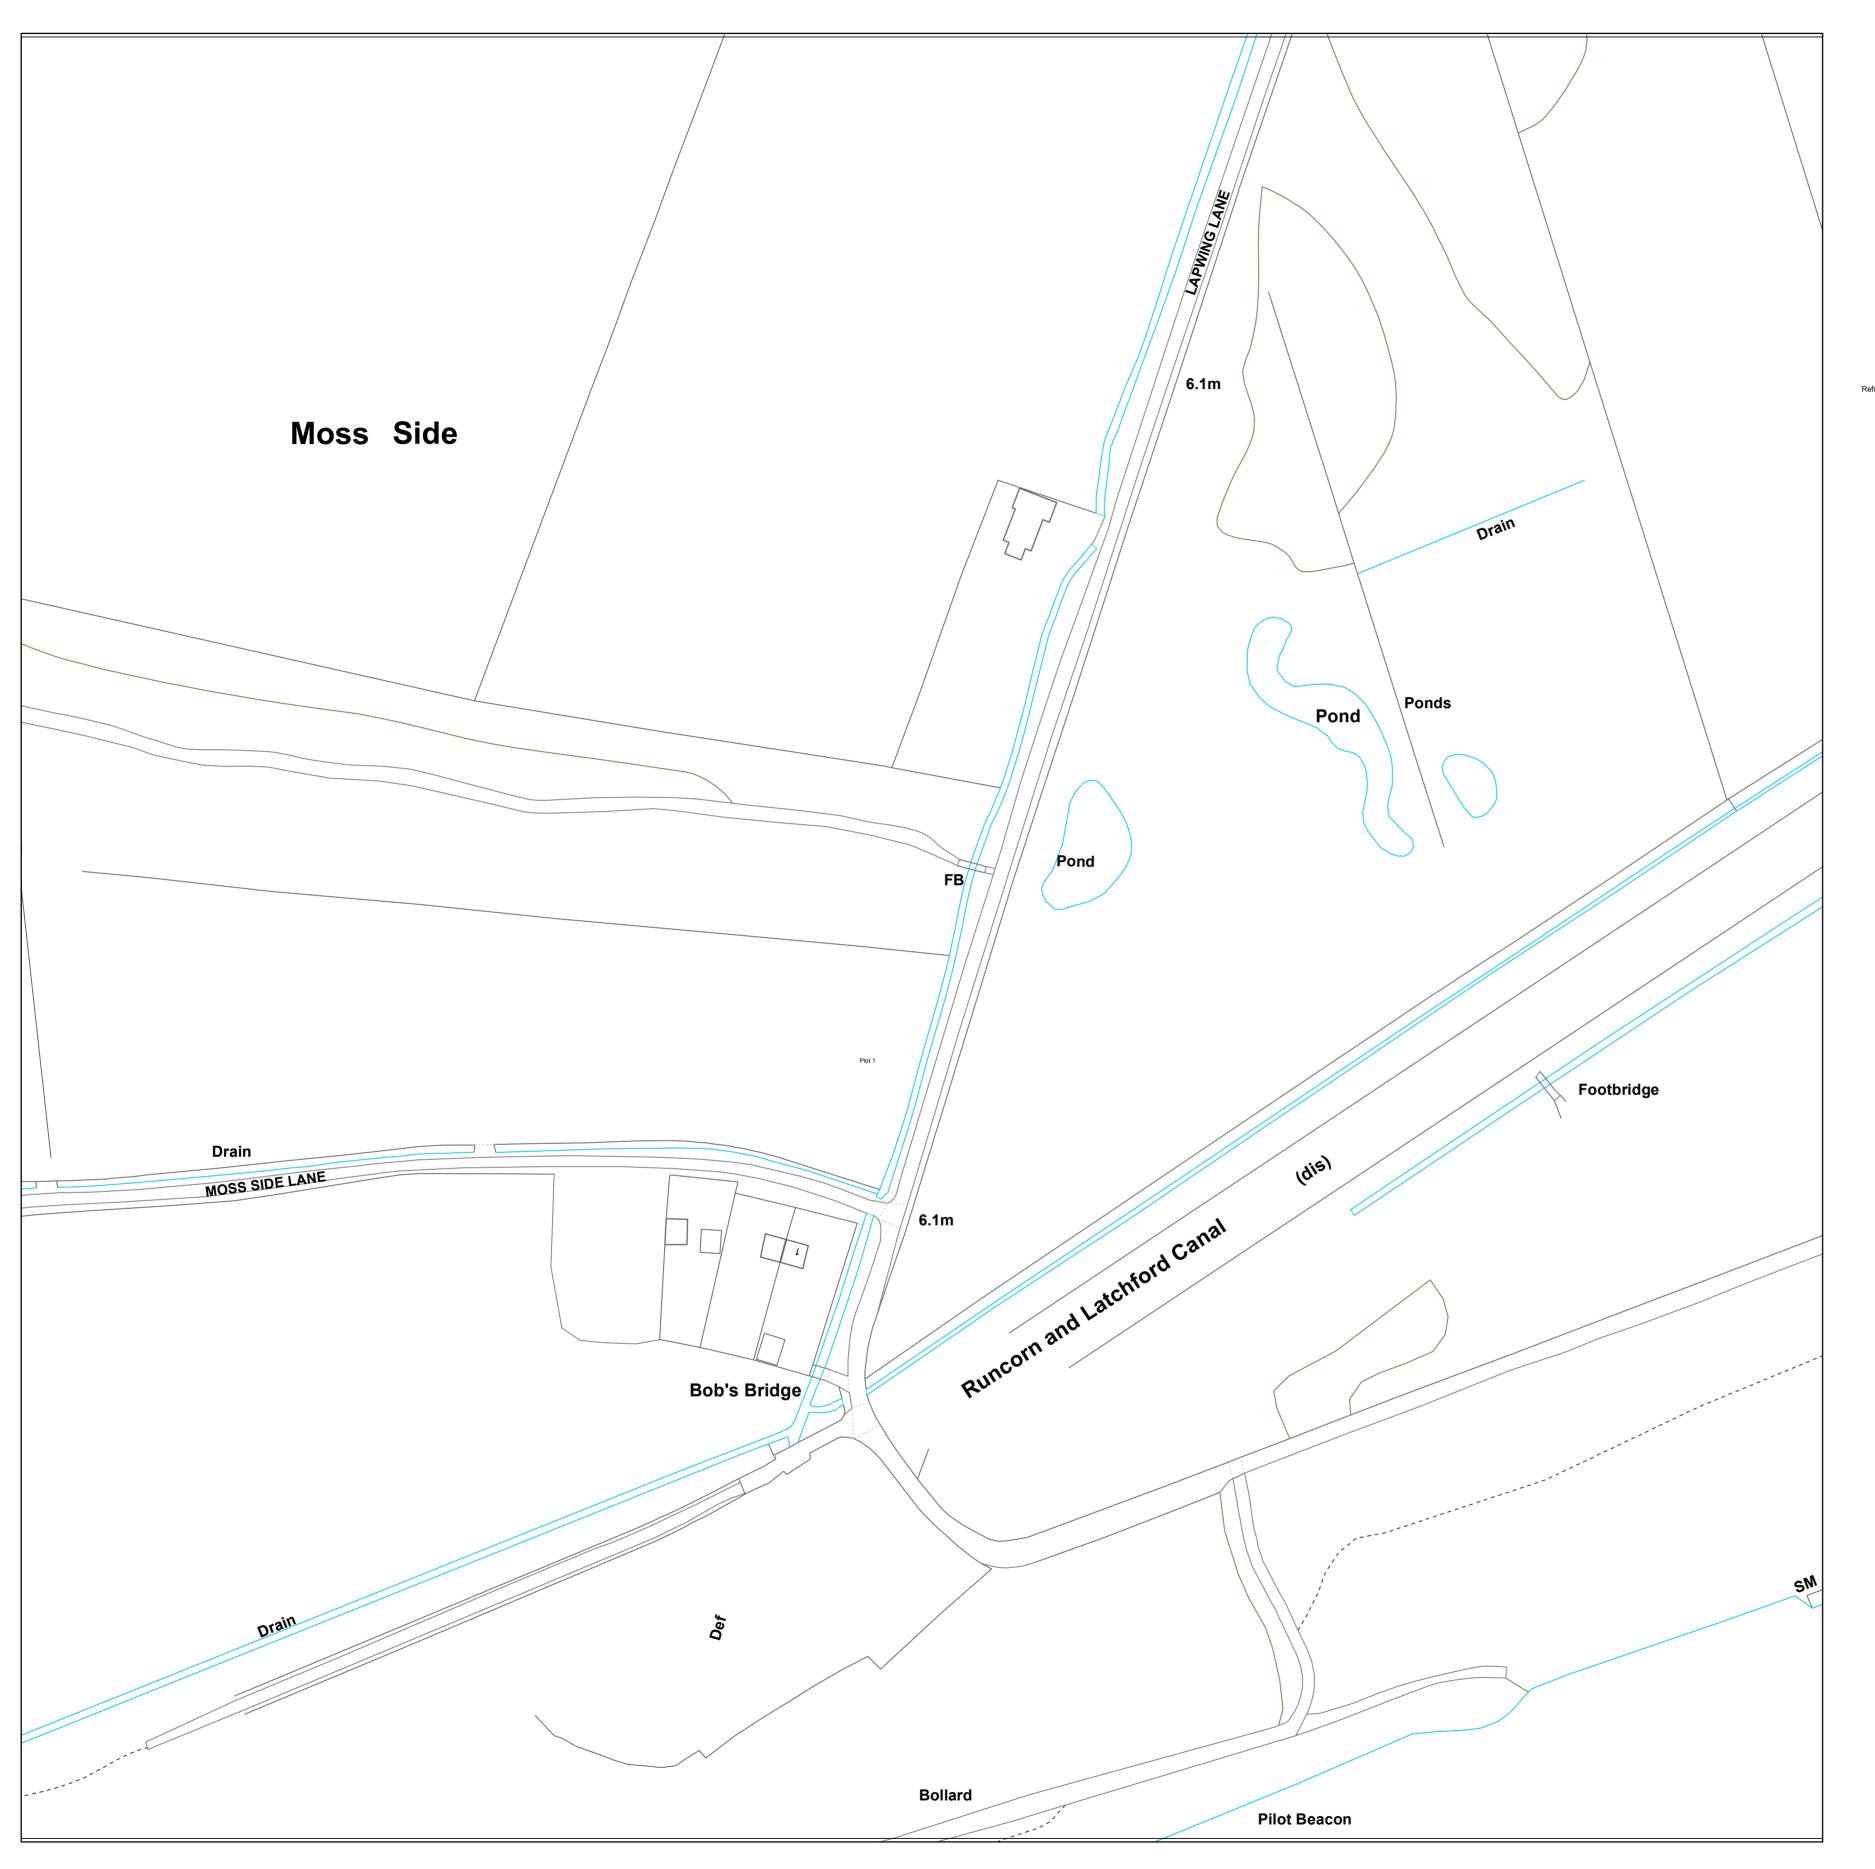Pitch Fibre

MAC Masonry, Coursed

MAR Masonry, Random

WASTE WATER SYMBOLOGY

Foul Surface Combined

WW Site Termination

Non Return Valve

Extent of Survey

Head of System

🐼 🐼 🙆 Catchpit

WW Pumping Station

🗂 🛱 🔼 TJunction/Saddle

→ Sewer Overflow

OilInterceptor

√alve Chamber

WW Treatment Works

LEGEND

TR Trapezoidal

Septic Tank

Washout Chamber

Network Storage Tank

Orifice Plate
Orifice Plate
Orifice Plate
Penstock Chamber

Screen Chamber

P Discharge Point

→ ← → Outfall

MANHOLE FUNCTION

SW Surface Water
CO Combined
OV Overflow
SEWER SHAPE
CI Circular

FO Foul

EG Egg OV Oval

RE Rectangular
SQ Square

AC Asbestos Cement

RP Reinforced Plastic Matrix

CSB Concrete Segment Bolted
CSU Concrete Segment Unbolted

CC Concrete Box Culverted
PSC Plastic/Steel Composite

GRC Glass Reinforced Concrete

PE Polyethylene

CO Concrete

Foul Surface Combined Overflow

🞳 🞳 🔓 DropShaft

● Hydrobrake/Vortex

Inspection Chamber

Contaminated Surface Water

Sludge Pumping Station

Surface Combined Overflow

Highway Drain, Private

ABANDONED PIPE

→ MainSewer
→ Rising Main
→ Highway Drain
→ Sludge Main

Sludge Main, Public

Sludge Main, Private

Sludge Main, S104

CK Control Kiosk

Unspecified

OS Sheet No: SJ5685SE

Scale: 1:1250 Date: 22/03/2018

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Sheet 1 of 1




SEWER RECORDS

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OS Sheet No: SJ5985NW

Scale: 1:1250 Date: 22/03/2018

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Sheet 1 of 1 **United**Utilities ping life flow smoothly

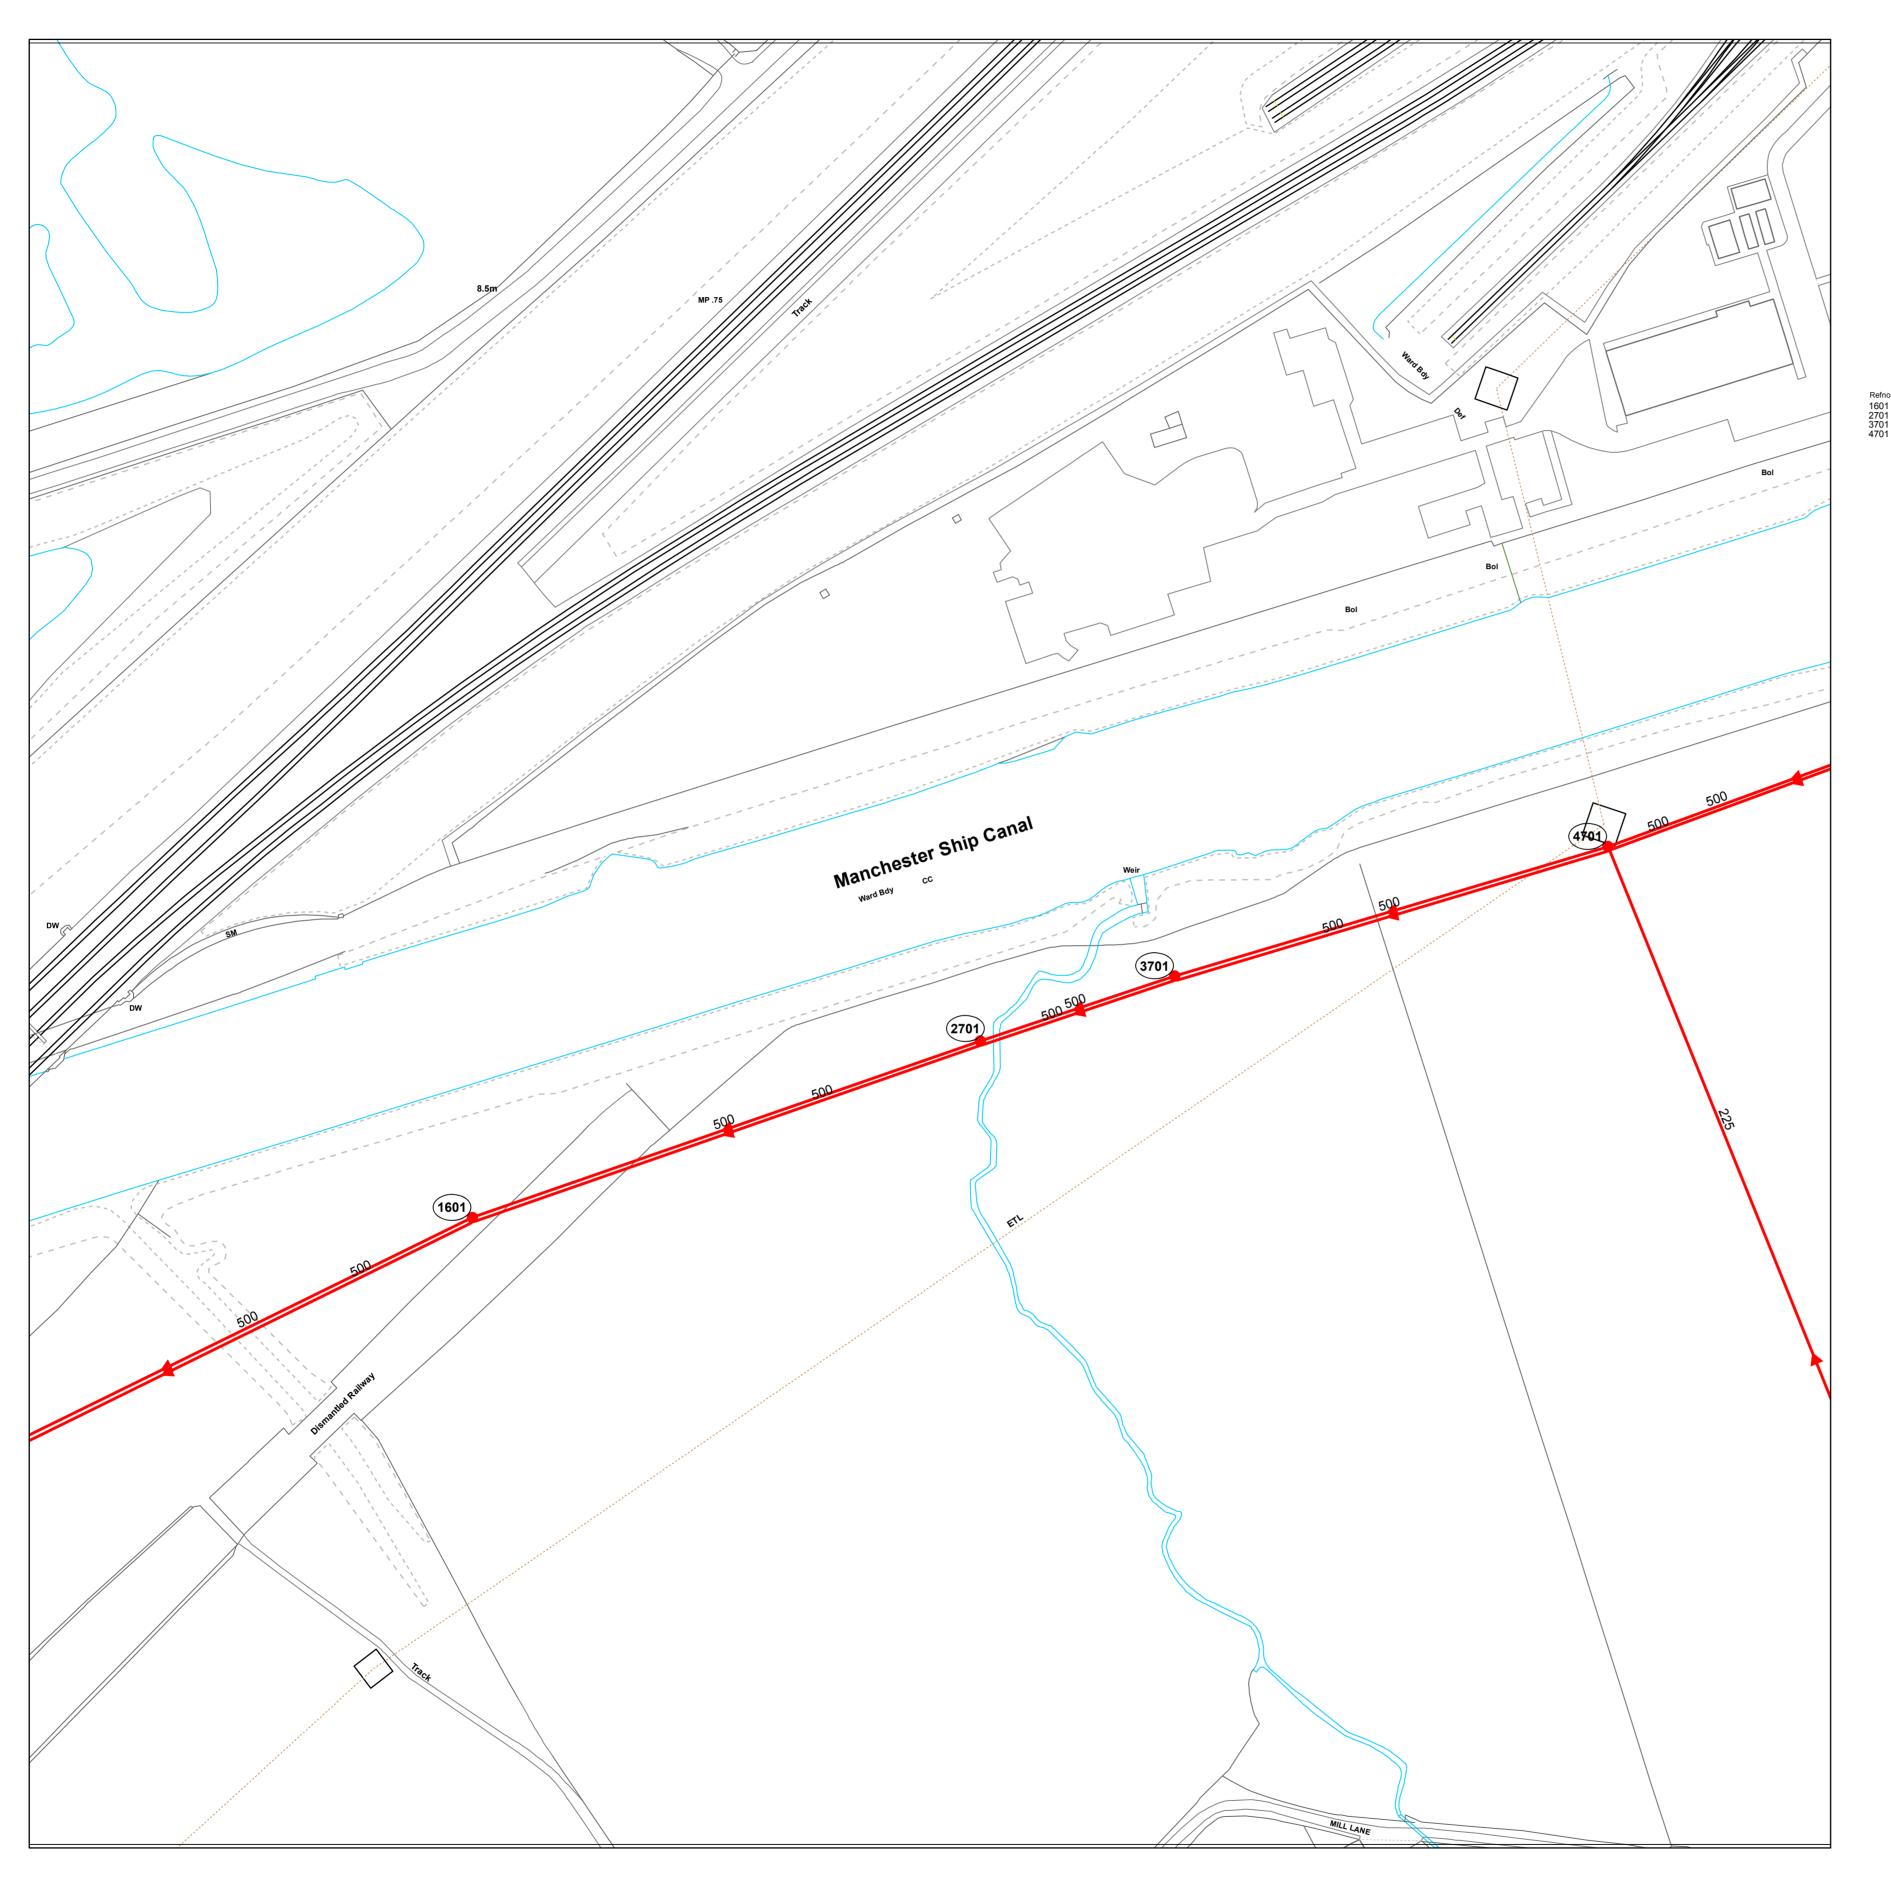
WASTE WATER SYMBOLOGY Surface Combined Overflow Highway Drain, Private Foul Surface Combined ——— Sludge Main, Public — 🛌 - Sludge Main, Private — ► – Sludge Main, S104 **ABANDONED PIPE** → MainSewer Rising Main → - - Highway Drain Sludge Main Contaminated Surface Water ▲ ▲ WW Pumping Station Sludge Pumping Station → Sewer Overflow Washout Chamber WW Treatment Works Network Storage Tank Orifice Plate Penstock Chamber Foul Surface Combined Overflow Screen Chamber P Discharge Point Unspecified → ← → Outfall LEGEND MANHOLE FUNCTION FO Foul SW Surface Water CO Combined OV Overflow **SEWER SHAPE** CI Circular TR Trapezoidal EG Egg OV Oval FT Flat Top RE Rectangular SQ Square SEWER MATERIAL DI Ductile Iron AC Asbestos Cement PVC Polyvinyl Chloride PE Polyethylene RP Reinforced Plastic Matrix CO Concrete CSB Concrete Segment Bolted CSU Concrete Segment Unbolted PF Pitch Fibre CC Concrete Box Culverted PSC Plastic/Steel Composite MAC Masonry, Coursed GRC Glass Reinforced Concrete MAR Masonry, Random GRP Glass Reinforced Plastic U Unspecified copyright and database rights [2016] Ordnance Survey 100022432.

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4 Nodes

SEWER RECORDS



Surface Combined Overflow — M— — M— — M— Rising Main, S104 Highway Drain, Private Foul Surface Combined WW Site Termination Sludge Main, Public — 🛌 - Sludge Main, Private — ► – Sludge Main, S104 Non Return Valve ABANDONED PIPE Extent of Survey → MainSewer Rising Main → - - Highway Drain Sludge Main Head of System Hydrobrake / Vortex Inspection Chamber 🖎 🖎 🖎 Catchpit Contaminated Surface Water WW Pumping Station Sludge Pumping Station → i→ Sewer Overflow 🗂 🗂 🖰 TJunction/Saddle OilInterceptor √c Valve Chamber ● Washout Chamber 🞳 🧬 🔓 DropShaft WW Treatment Works Network Storage Tank 💞 🔐 💕 Orifice Plate O O Vortex Chamber Foul Surface Combined Overflow Screen Chamber CK Control Kiosk 🎳 🎳 🎳 Discharge Point Unspecified → ← → Outfall **LEGEND** MANHOLE FUNCTION FO Foul SW Surface Water CO Combined OV Overflow SEWER SHAPE CI Circular TR Trapezoidal EG Egg OV Oval RE Rectangular SQ Square DI Ductile Iron AC Asbestos Cement PVC Polyvinyl Chloride PE Polyethylene CO Concrete CSB Concrete Segment Bolted CSU Concrete Segment Unbolted CC Concrete Box Culverted PSC Plastic/Steel Composite MAC Masonry, Coursed GRC Glass Reinforced Concrete MAR Masonry, Random GRP Glass Reinforced Plastic U Unspecified The position of the underground apparatus shown on this plan is approximate only and is given in accordance with the best information currently available. United Utilities Water will not accept liability for any loss or damage caused by the actual position being different from those shown. Crown copyright and database rights [2016] Ordnance Survey 100022432. OS Sheet No: SJ5885NW

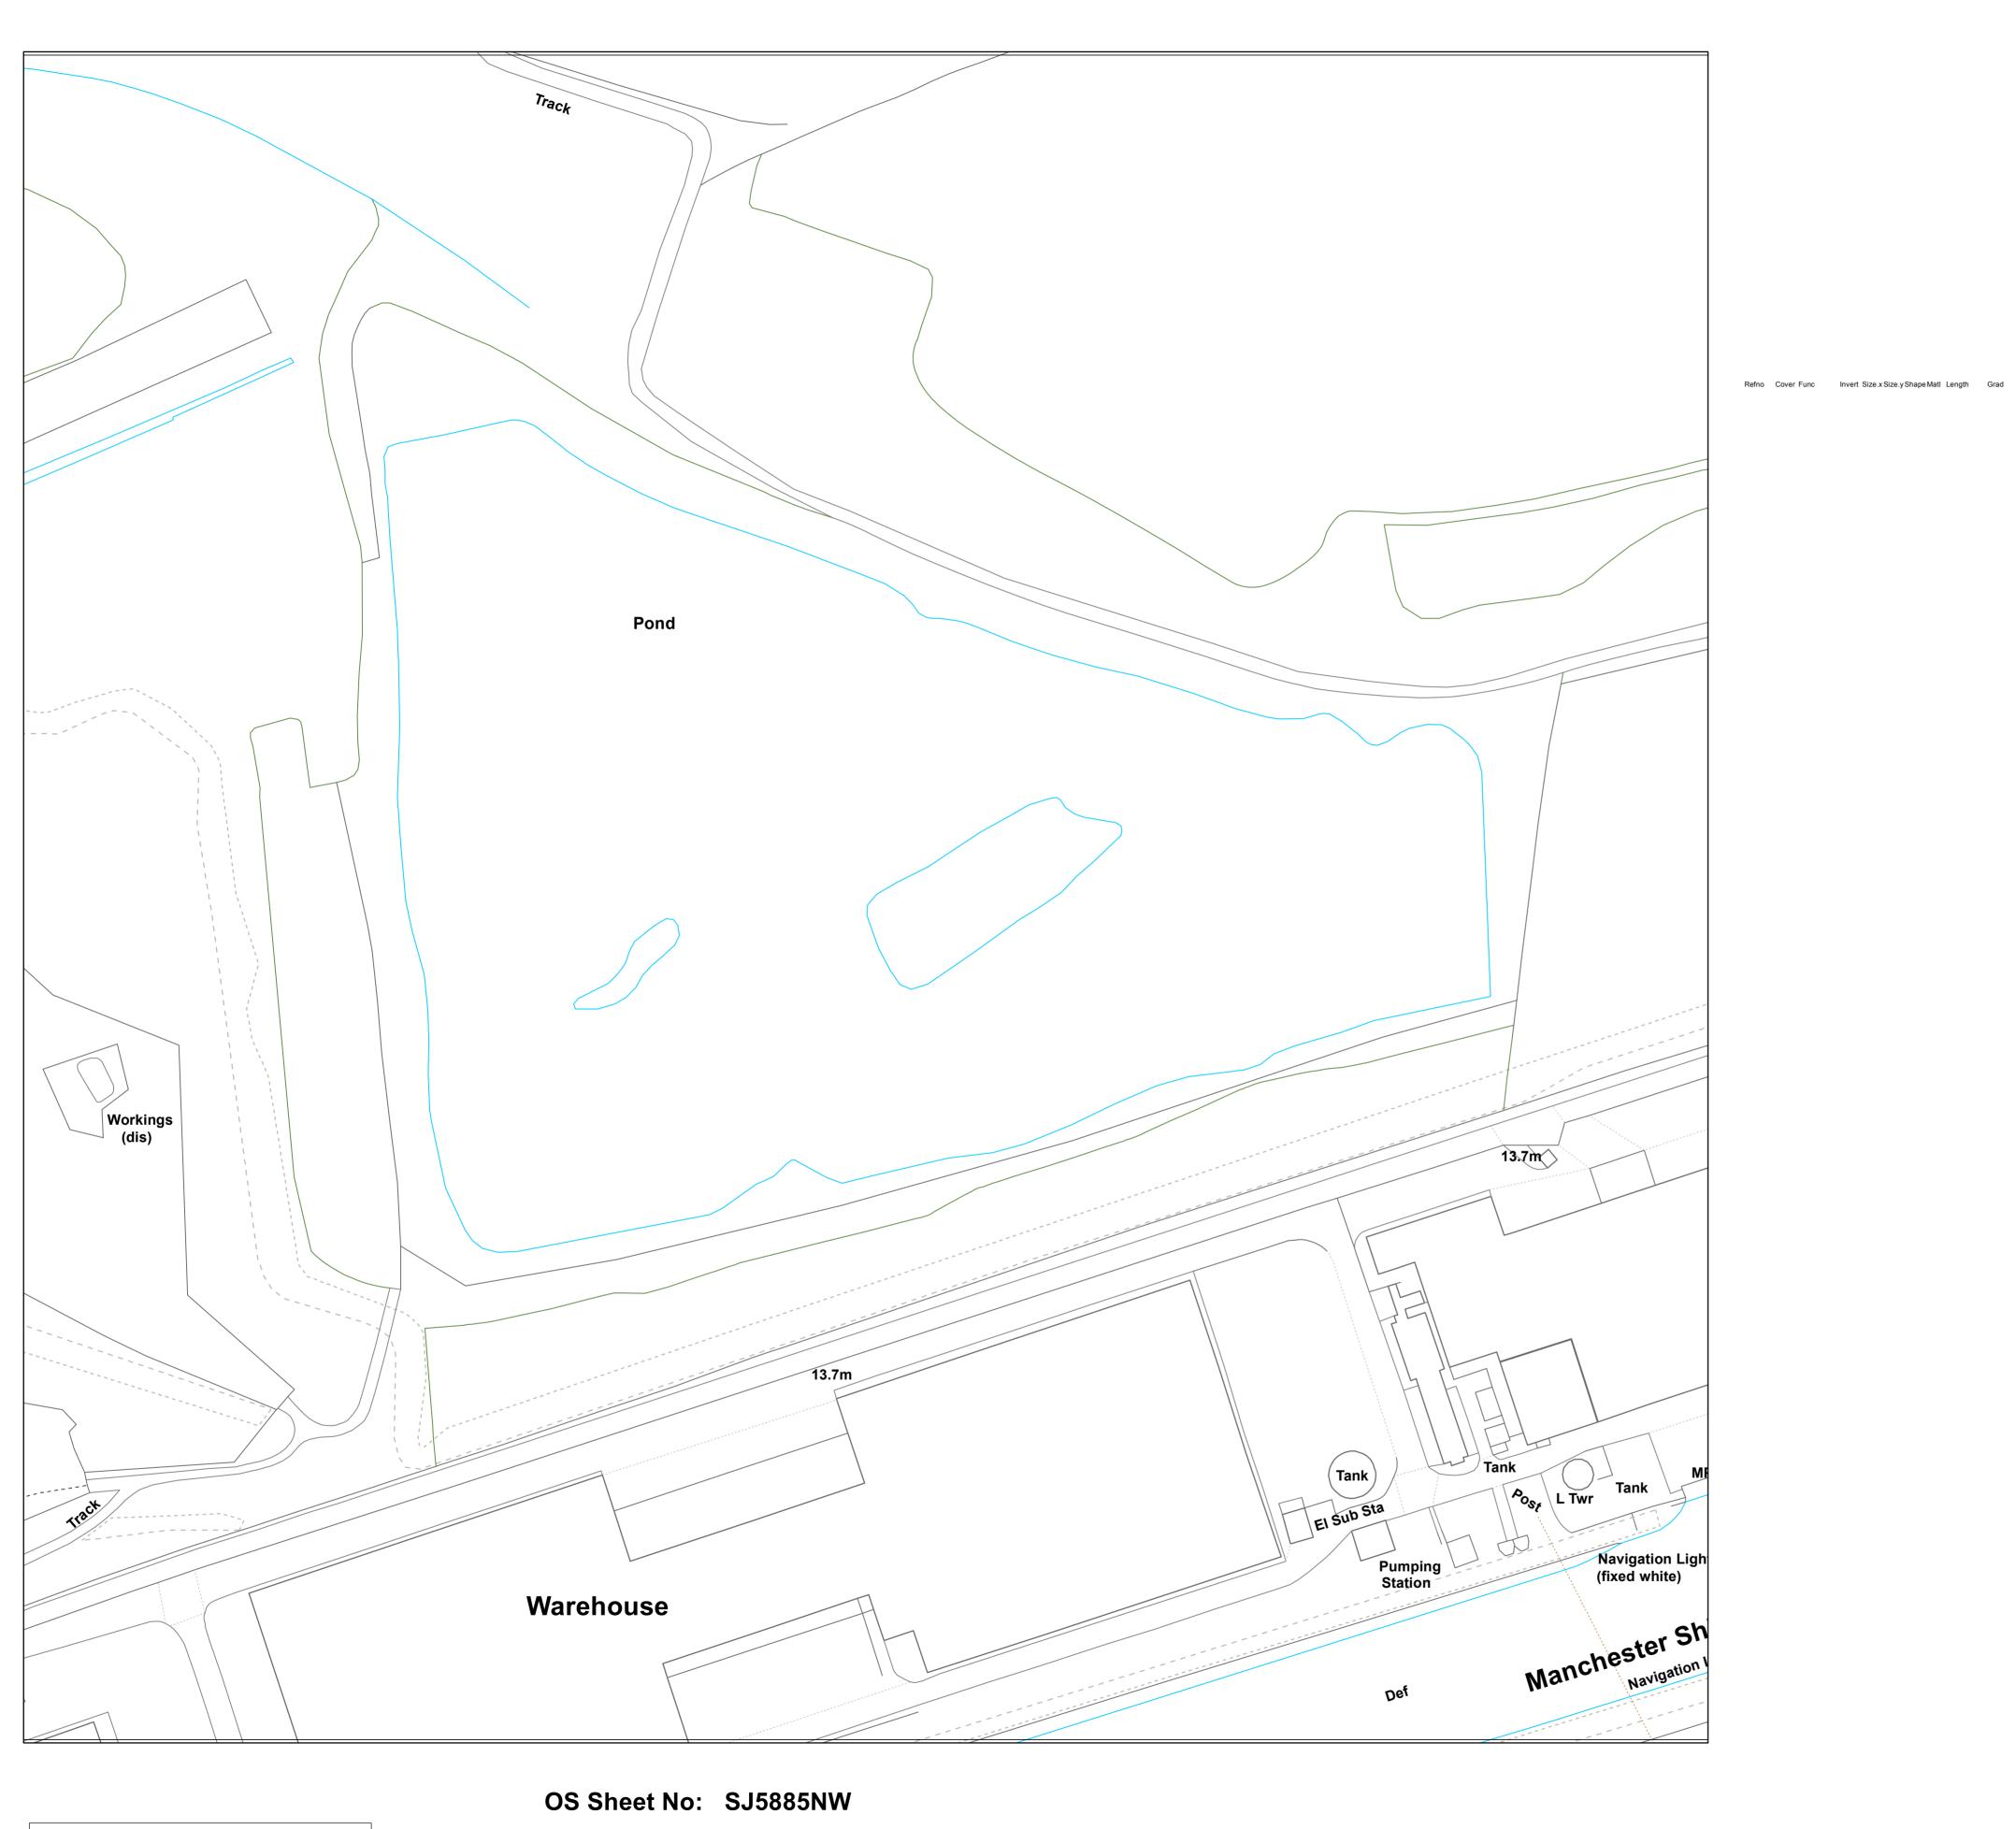WASTE WATER SYMBOLOGY

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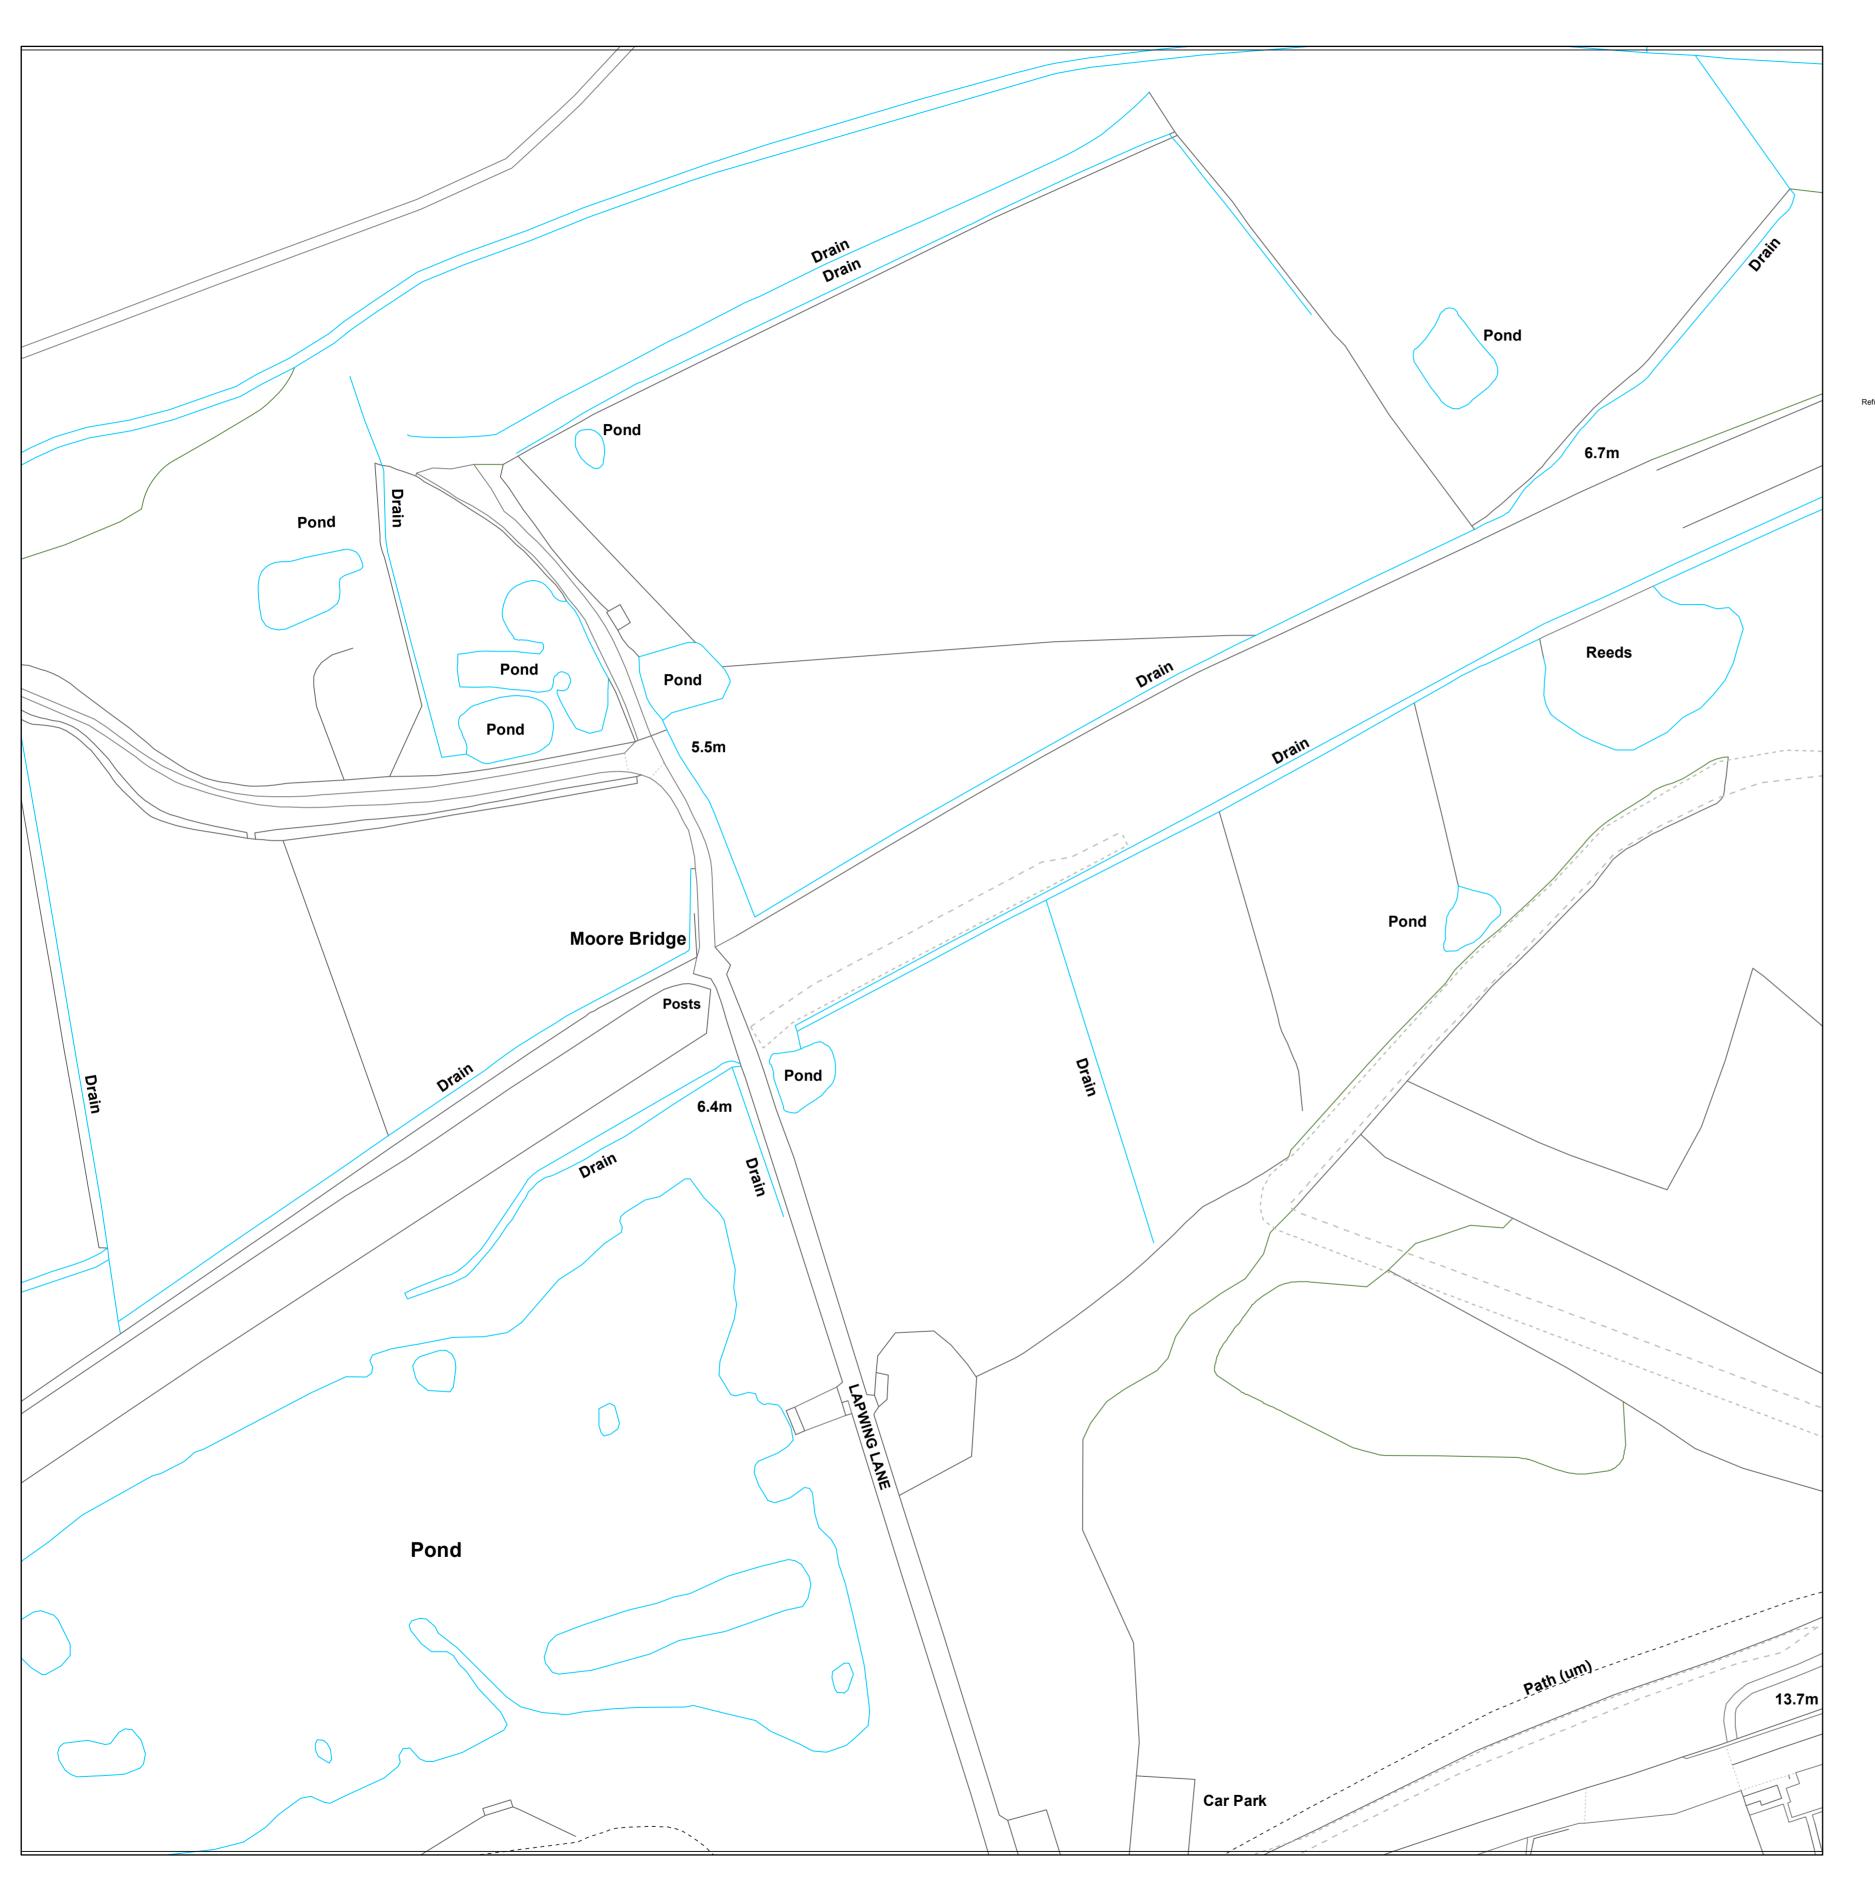
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United Utilities

Solving life flow smoothly


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Rising Main → - - Highway Drain Sludge Main Head of System Hydrobrake / Vortex Inspection Chamber 🐼 🖎 🥝 Catchpit Contaminated Surface Water WW Pumping Station Sludge Pumping Station → i→ Sewer Overflow 🗂 🗂 🖰 TJunction/Saddle OilInterceptor vo vo Valve Chamber Washout Chamber 🞳 🧬 🔓 DropShaft WW Treatment Works ST Septic Tank Network Storage Tank 💞 🔐 💕 Orifice Plate O O Vortex Chamber Foul Surface Combined Overflow Screen Chamber P Discharge Point Unspecified → ← → Outfall LEGEND MANHOLE FUNCTION FO Foul SW Surface Water CO Combined OV Overflow **SEWER SHAPE** CI Circular TR Trapezoidal EG Egg OV Oval FT Flat Top RE Rectangular SQ Square DI Ductile Iron AC Asbestos Cement PVC Polyvinyl Chloride PE Polyethylene RP Reinforced Plastic Matrix CO Concrete CSB Concrete Segment Bolted CSU Concrete Segment Unbolted Pitch Fibre CC Concrete Box Culverted PSC Plastic/Steel Composite MAC Masonry, Coursed GRC Glass Reinforced Concrete MAR Masonry, Random GRP Glass Reinforced Plastic U Unspecified The position of the underground apparatus shown on this plan is approximate only and is given in copyright and database rights [2016] Ordnance Survey 100022432.

WASTE WATER SYMBOLOGY

WW Site Termination

Non Return Valve

Extent of Survey

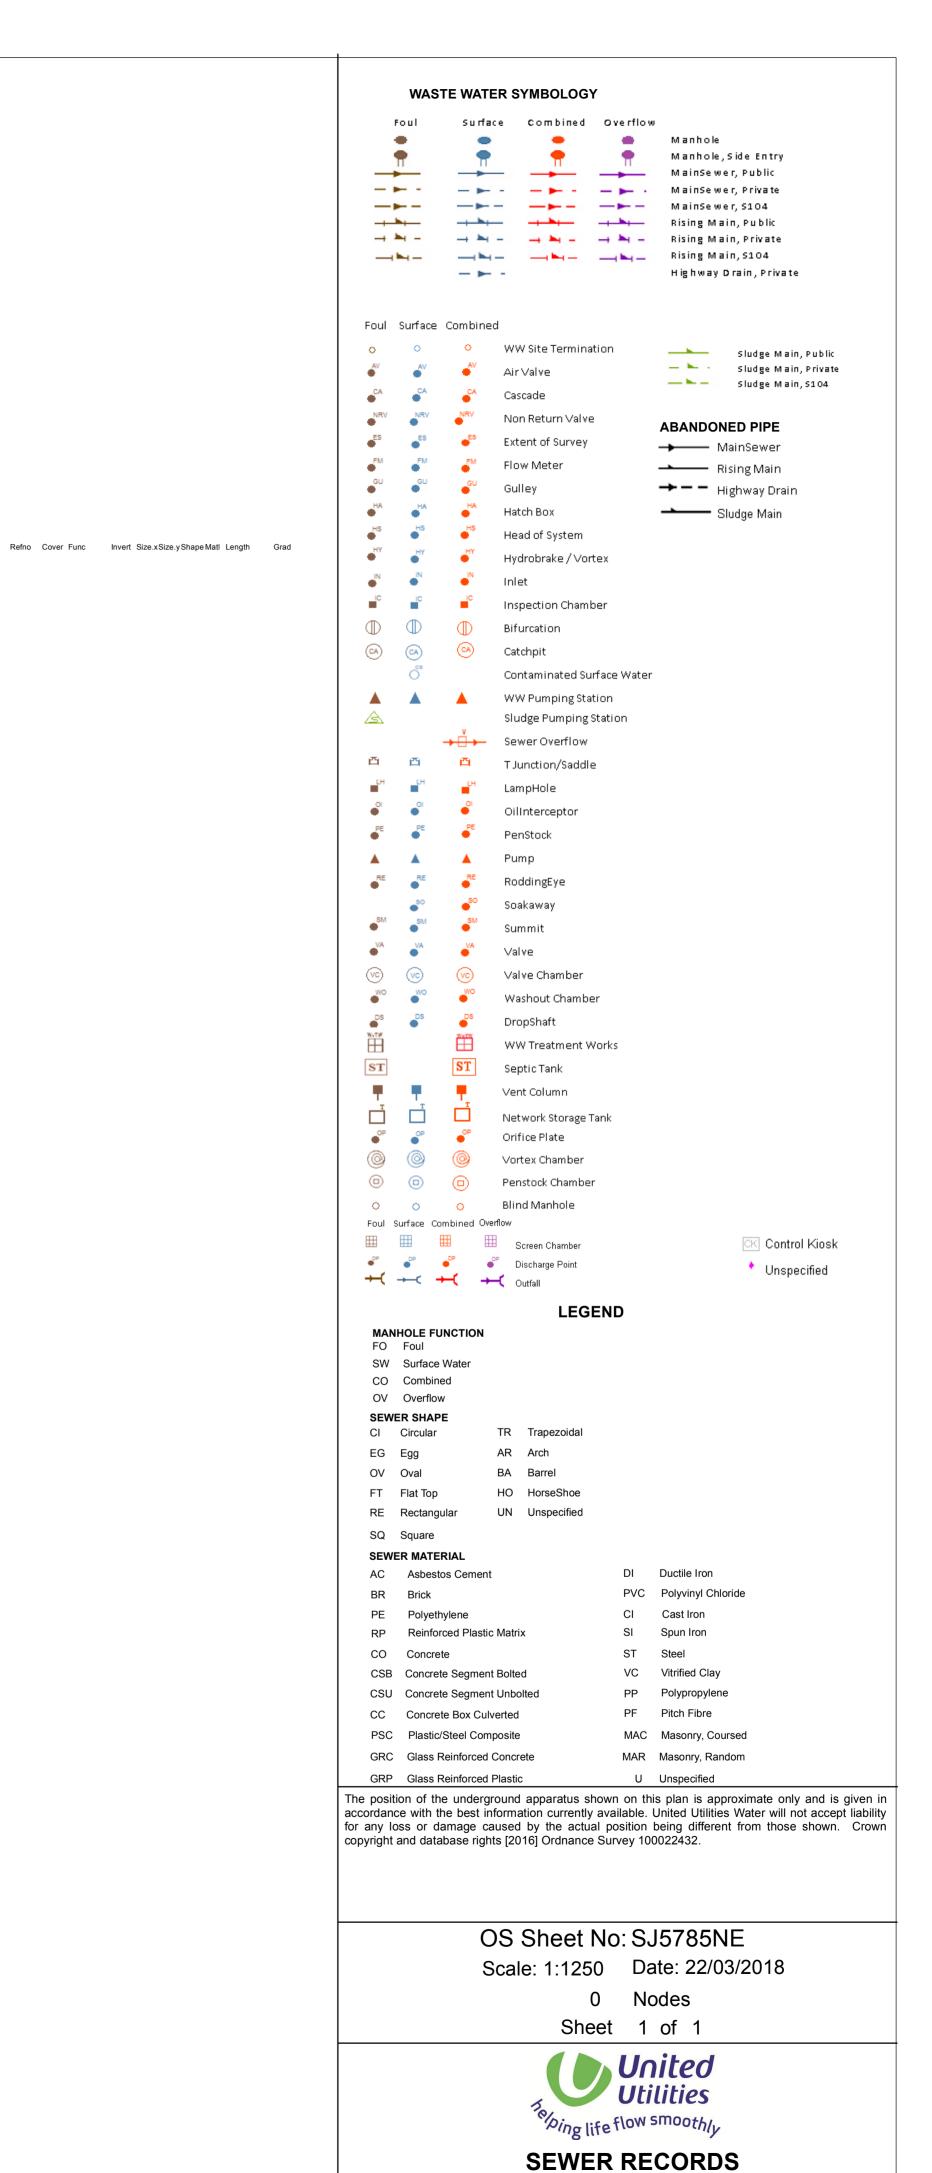Foul Surface Combined

🞳 🞳 🞳 Air Valve

Foul Surface Combined Overflow

— — — — — — — Rising Main, S104

Highway Drain, Private

Sludge Main, Public — 🛌 - Sludge Main, Private

— ► – Sludge Main, S104

ABANDONED PIPE

→ MainSewer

accordance with the best information currently available. United Utilities Water will not accept liability for any loss or damage caused by the actual position being different from those shown. Crown

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SEWER RECORDS

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Foul Surface Combined WW Site Termination Sludge Main, Public — 느 - Sludge Main, Private 🞳 🞳 🞳 Air Valve — ► – Sludge Main, S104 💞 🚰 Cascade Non Return Valve ABANDONED PIPE 🎳 🞳 🎳 Extent of Survey → MainSewer 🎳 🎳 🎳 Flow Meter Rising Main → - - Highway Drain Sludge Main 🞳 🎳 Head of System 🎳 🎳 Hydrobrake / Vortex 🖺 🖺 Inspection Chamber Bifurcation 🐼 🖎 🥝 Catchpit Contaminated Surface Water WW Pumping Station Sludge Pumping Station → i→ Sewer Overflow 🗂 🗂 🗂 T Junction/Saddle OilInterceptor √c √c Valve Chamber ● Washout Chamber 🞳 🧬 🔓 DropShaft WW Treatment Works Septic Tank Vent Column Network Storage Tank 💞 🔐 💕 Orifice Plate O O Vortex Chamber O O O Blind Manhole Foul Surface Combined Overflow Screen Chamber CK Control Kiosk P Discharge Point Unspecified → ← → Outfall **LEGEND** MANHOLE FUNCTION FO Foul SW Surface Water CO Combined OV Overflow **SEWER SHAPE** CI Circular TR Trapezoidal EG Egg OV Oval FT Flat Top HO HorseShoe RE Rectangular UN Unspecified SQ Square SEWER MATERIAL DI Ductile Iron AC Asbestos Cement PVC Polyvinyl Chloride PE Polyethylene RP Reinforced Plastic Matrix CO Concrete CSB Concrete Segment Bolted CSU Concrete Segment Unbolted PF Pitch Fibre CC Concrete Box Culverted PSC Plastic/Steel Composite MAC Masonry, Coursed GRC Glass Reinforced Concrete MAR Masonry, Random GRP Glass Reinforced Plastic U Unspecified copyright and database rights [2016] Ordnance Survey 100022432.

WASTE WATER SYMBOLOGY

Foul Surface Combined Overflow

— Main, S104

Highway Drain, Private

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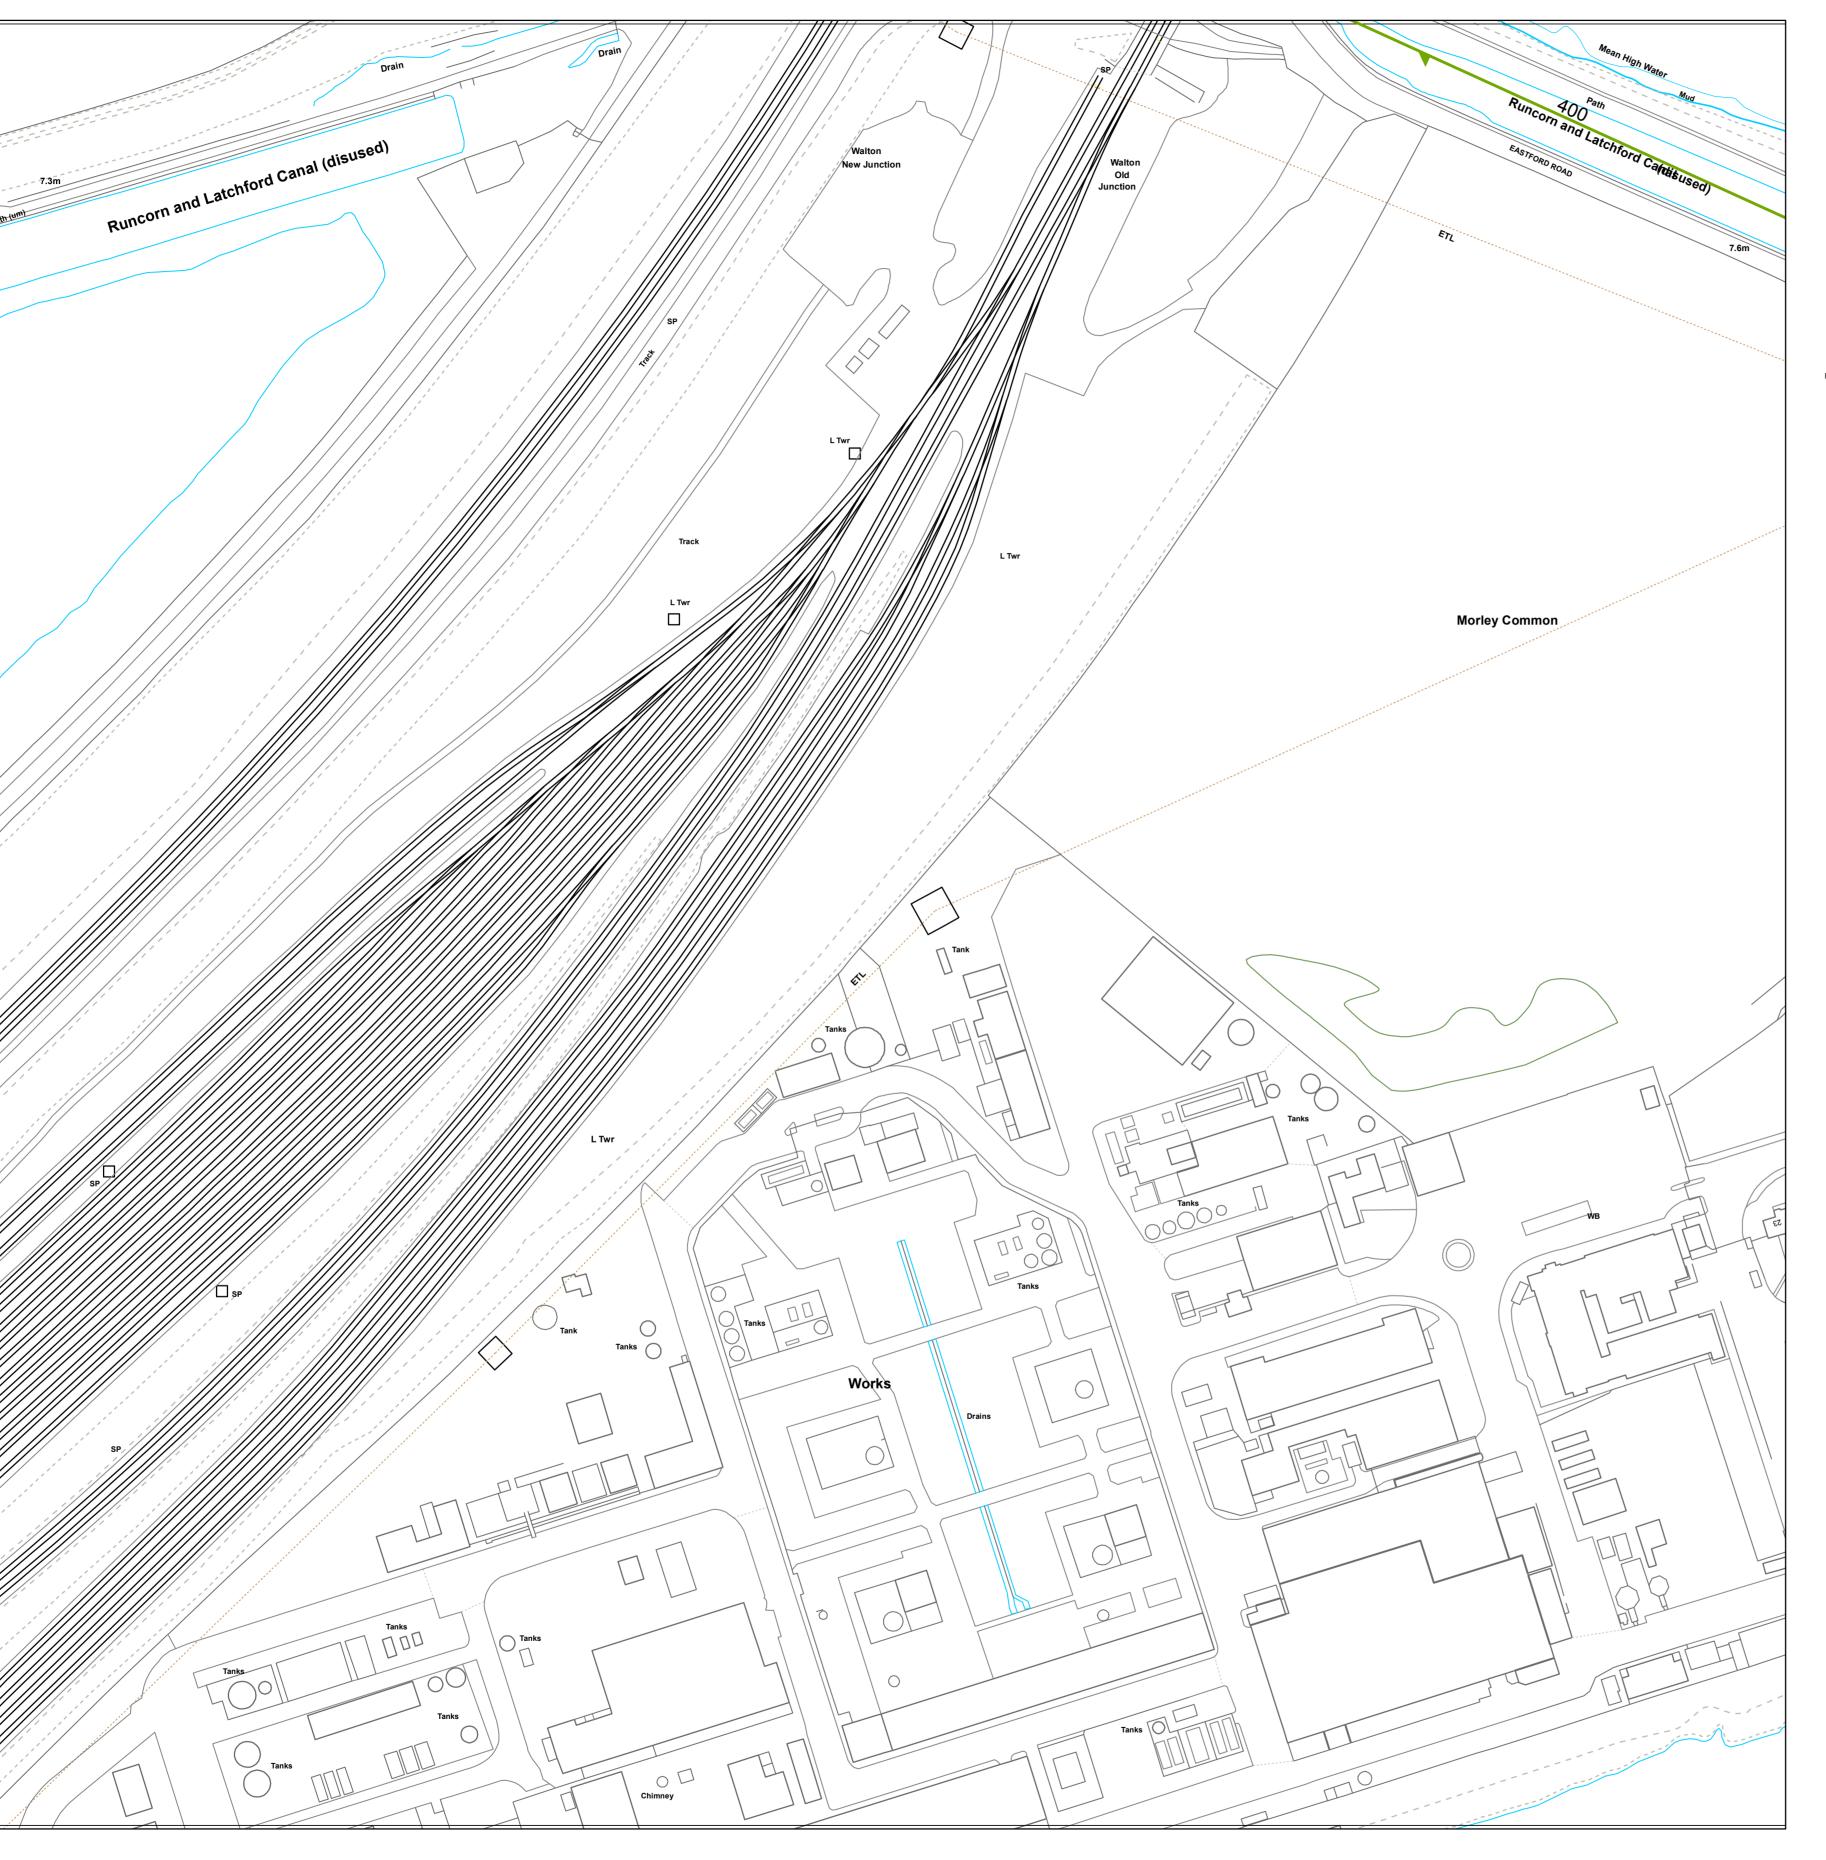
Sheet 1 of 1



SEWER RECORDS

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Highway Drain, Private Foul Surface Combined ——— Sludge Main, Public — 🛌 - Sludge Main, Private — ► – Sludge Main, S104 **ABANDONED PIPE** → MainSewer Rising Main → - - Highway Drain Sludge Main Contaminated Surface Water WW Pumping Station Sludge Pumping Station → i→ Sewer Overflow Washout Chamber WW Treatment Works Network Storage Tank Orifice Plate Penstock Chamber Foul Surface Combined Overflow CK Control Kiosk Unspecified → ← → Outfall **LEGEND** MANHOLE FUNCTION FO Foul SW Surface Water CO Combined OV Overflow SEWER SHAPE CI Circular EG Egg RE Rectangular SQ Square DI Ductile Iron AC Asbestos Cement PVC Polyvinyl Chloride Polyethylene RP Reinforced Plastic Matrix CO Concrete CSB Concrete Segment Bolted CSU Concrete Segment Unbolted CC Concrete Box Culverted PSC Plastic/Steel Composite MAC Masonry, Coursed GRC Glass Reinforced Concrete MAR Masonry, Random GRP Glass Reinforced Plastic U Unspecified The position of the underground apparatus shown on this plan is approximate only and is given in accordance with the best information currently available. United Utilities Water will not accept liability for any loss or damage caused by the actual position being different from those shown. Crown copyright and database rights [2016] Ordnance Survey 100022432. OS Sheet No: SJ5986SE

WASTE WATER SYMBOLOGY

Surface Combined Overflow

Scale: 1:1250 Date: 22/03/2018

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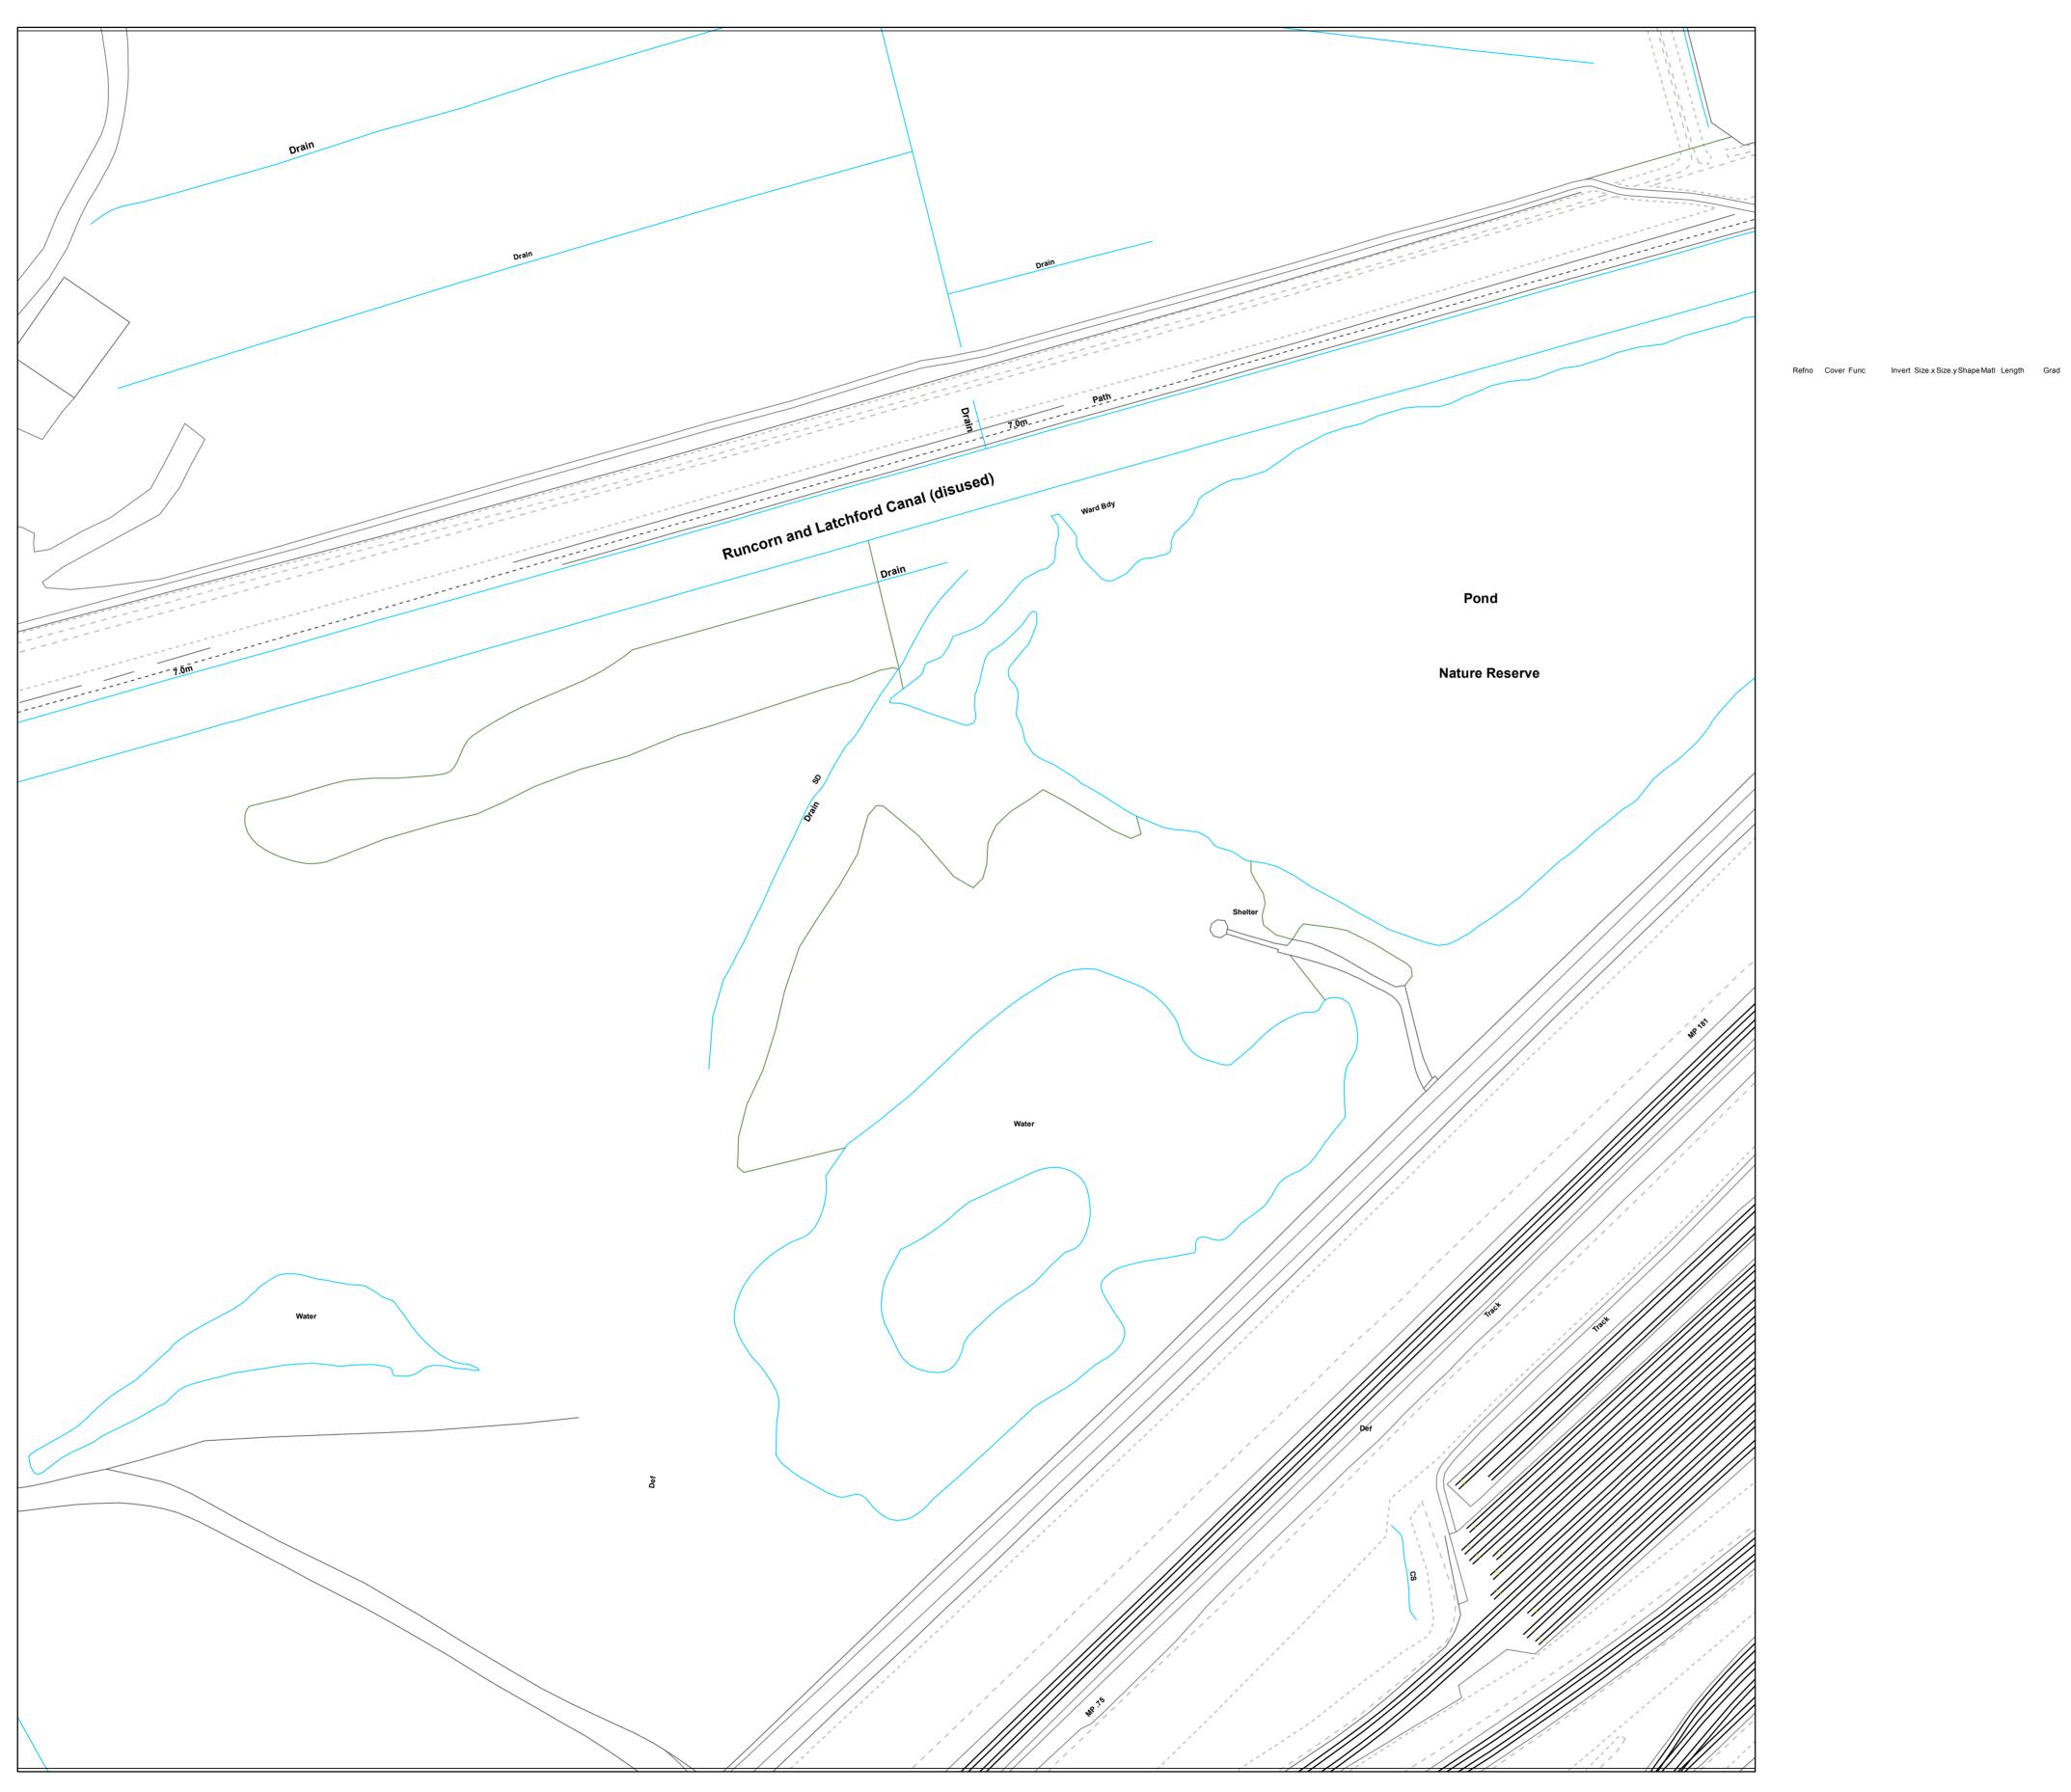
Sheet 1 of 1



SEWER RECORDS


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OS Sheet No: SJ5986SW

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> CC Concrete Box Culverted PSC Plastic/Steel Composite MAC Masonry, Coursed GRC Glass Reinforced Concrete MAR Masonry, Random GRP Glass Reinforced Plastic U Unspecified The position of the underground apparatus shown on this plan is approximate only and is given in accordance with the best information currently available. United Utilities Water will not accept liability for any loss or damage caused by the actual position being different from those shown. Crown copyright and database rights [2016] Ordnance Survey 100022432.

DI Ductile Iron

PF Pitch Fibre

PVC Polyvinyl Chloride

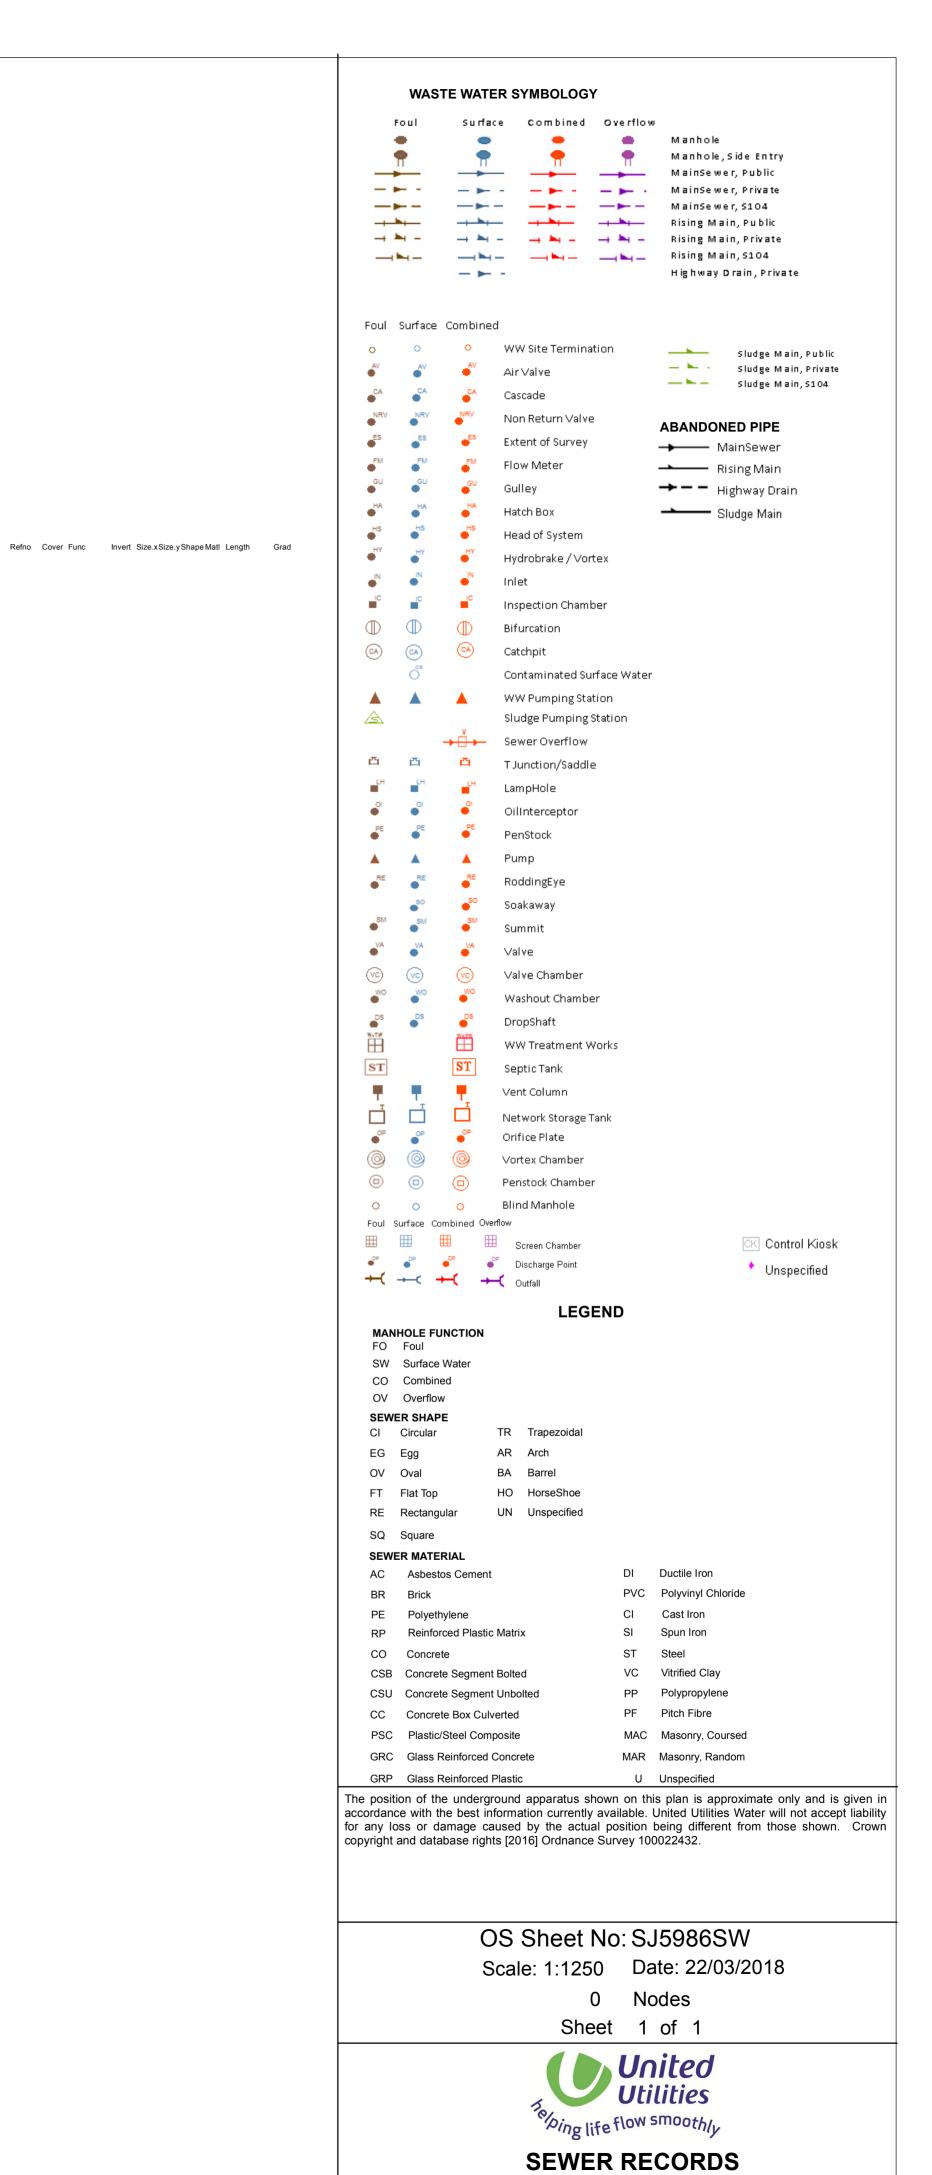WASTE WATER SYMBOLOGY

WW Site Termination

Non Return Valve

Extent of Survey

Hydrobrake / Vortex

Inspection Chamber

Contaminated Surface Water

Sludge Pumping Station

Flow Meter

Head of System

WW Pumping Station

🗂 🗂 🖰 TJunction/Saddle

√c √c Valve Chamber Washout Chamber

🞳 🧬 🔓 DropShaft

→ i→ Sewer Overflow

OilInterceptor

WW Treatment Works

LEGEND

TR Trapezoidal

ST Septic Tank

Network Storage Tank

💞 🔐 💕 Orifice Plate O O Vortex Chamber

Screen Chamber

P Discharge Point

→ ← → Outfall

Foul Surface Combined Overflow

MANHOLE FUNCTION

SW Surface Water CO Combined OV Overflow **SEWER SHAPE** CI Circular

FO Foul

EG Egg OV Oval FT Flat Top

RE Rectangular SQ Square SEWER MATERIAL

AC Asbestos Cement

RP Reinforced Plastic Matrix

CSB Concrete Segment Bolted CSU Concrete Segment Unbolted

PE Polyethylene

CO Concrete

Foul Surface Combined

e dir Valve

🐼 🖎 🥝 Catchpit

Foul Surface Combined Overflow

— — — — — — — Rising Main, S104

Highway Drain, Private

Sludge Main, Public — 🛌 - Sludge Main, Private

— ► – Sludge Main, S104

CK Control Kiosk

Unspecified

ABANDONED PIPE

→ MainSewer

Rising Main → - - Highway Drain Sludge Main

OS Sheet No: SJ5886SE

Scale: 1:1250 Date: 22/03/2018

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Sheet 1 of 1



SEWER RECORDS

OS Sheet No: SJ5886SE

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GRP Glass Reinforced Plastic U Unspecified

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DI Ductile Iron

PF Pitch Fibre

MAC Masonry, Coursed

MAR Masonry, Random

PVC Polyvinyl Chloride

WASTE WATER SYMBOLOGY

Foul Surface Combined

Surface Combined Overflow

WW Site Termination

Non Return Valve

Head of System

Inspection Chamber

Contaminated Surface Water

Sludge Pumping Station

● Hydrobrake / Vortex

▲ ▲ WW Pumping Station

→ i→ Sewer Overflow

Valve Chamber Washout Chamber

WW Treatment Works

Network Storage Tank

LEGEND

Orifice Plate Vortex Chamber Penstock Chamber

TR Trapezoidal

HO HorseShoe

UN Unspecified

DropShaft

O O O Blind Manhole

Screen Chamber

P Discharge Point

→ ← → Outfall

Foul Surface Combined Overflow

MANHOLE FUNCTION

SW Surface Water
CO Combined
OV Overflow
SEWER SHAPE
CI Circular

FO Foul

EG Egg
OV Oval
FT Flat Top

RE Rectangular

AC Asbestos Cement

RP Reinforced Plastic Matrix

CSB Concrete Segment Bolted
CSU Concrete Segment Unbolted

CC Concrete Box Culverted
PSC Plastic/Steel Composite

GRC Glass Reinforced Concrete

PE Polyethylene

CO Concrete

SQ Square
SEWER MATERIAL

Extent of Survey

Highway Drain, Private

ABANDONED PIPE

→ MainSewer

→ Rising Main

→ Highway Drain

→ Sludge Main

Sludge Main, Public

Sludge Main, Private

Sludge Main, S104

Unspecified

OS Sheet No: SJ5886SW Scale: 1:1250 Date: 22/03/2018

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Sheet 1 of 1

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Refno Cover Func Invert Size.x Size.y Shape Matl Length Grad Refno Cover Func Invert Size.xSize.yShapeMatl Length Grad

— — — — — — — Rising Main, S104 Highway Drain, Private Foul Surface Combined WW Site Termination Sludge Main, Public — 🛌 - Sludge Main, Private 🞳 🞳 🍧 Air∨alve — ► – Sludge Main, S104 Non Return Valve ABANDONED PIPE Extent of Survey → MainSewer Rising Main → - - Highway Drain Sludge Main 🎳 🎳 Head of System Hydrobrake / Vortex Inspection Chamber 🐼 🖎 બ Catchpit Contaminated Surface Water WW Pumping Station Sludge Pumping Station → i→ Sewer Overflow 🗂 🗂 🗂 T Junction/Saddle OilInterceptor √c √c Valve Chamber Washout Chamber 🞳 🧬 🔓 DropShaft WW Treatment Works ST Septic Tank Network Storage Tank 💞 🔐 💕 Orifice Plate O O Vortex Chamber O O O Blind Manhole Foul Surface Combined Overflow Screen Chamber P Discharge Point Unspecified → ← → Outfall LEGEND MANHOLE FUNCTION FO Foul SW Surface Water CO Combined OV Overflow **SEWER SHAPE** CI Circular TR Trapezoidal EG Egg OV Oval FT Flat Top RE Rectangular SQ Square SEWER MATERIAL DI Ductile Iron AC Asbestos Cement PVC Polyvinyl Chloride PE Polyethylene RP Reinforced Plastic Matrix CO Concrete CSB Concrete Segment Bolted CSU Concrete Segment Unbolted PF Pitch Fibre CC Concrete Box Culverted PSC Plastic/Steel Composite MAC Masonry, Coursed GRC Glass Reinforced Concrete MAR Masonry, Random GRP Glass Reinforced Plastic U Unspecified The position of the underground apparatus shown on this plan is approximate only and is given in accordance with the best information currently available. United Utilities Water will not accept liability for any loss or damage caused by the actual position being different from those shown. Crown copyright and database rights [2016] Ordnance Survey 100022432.

WASTE WATER SYMBOLOGY

Foul Surface Combined Overflow

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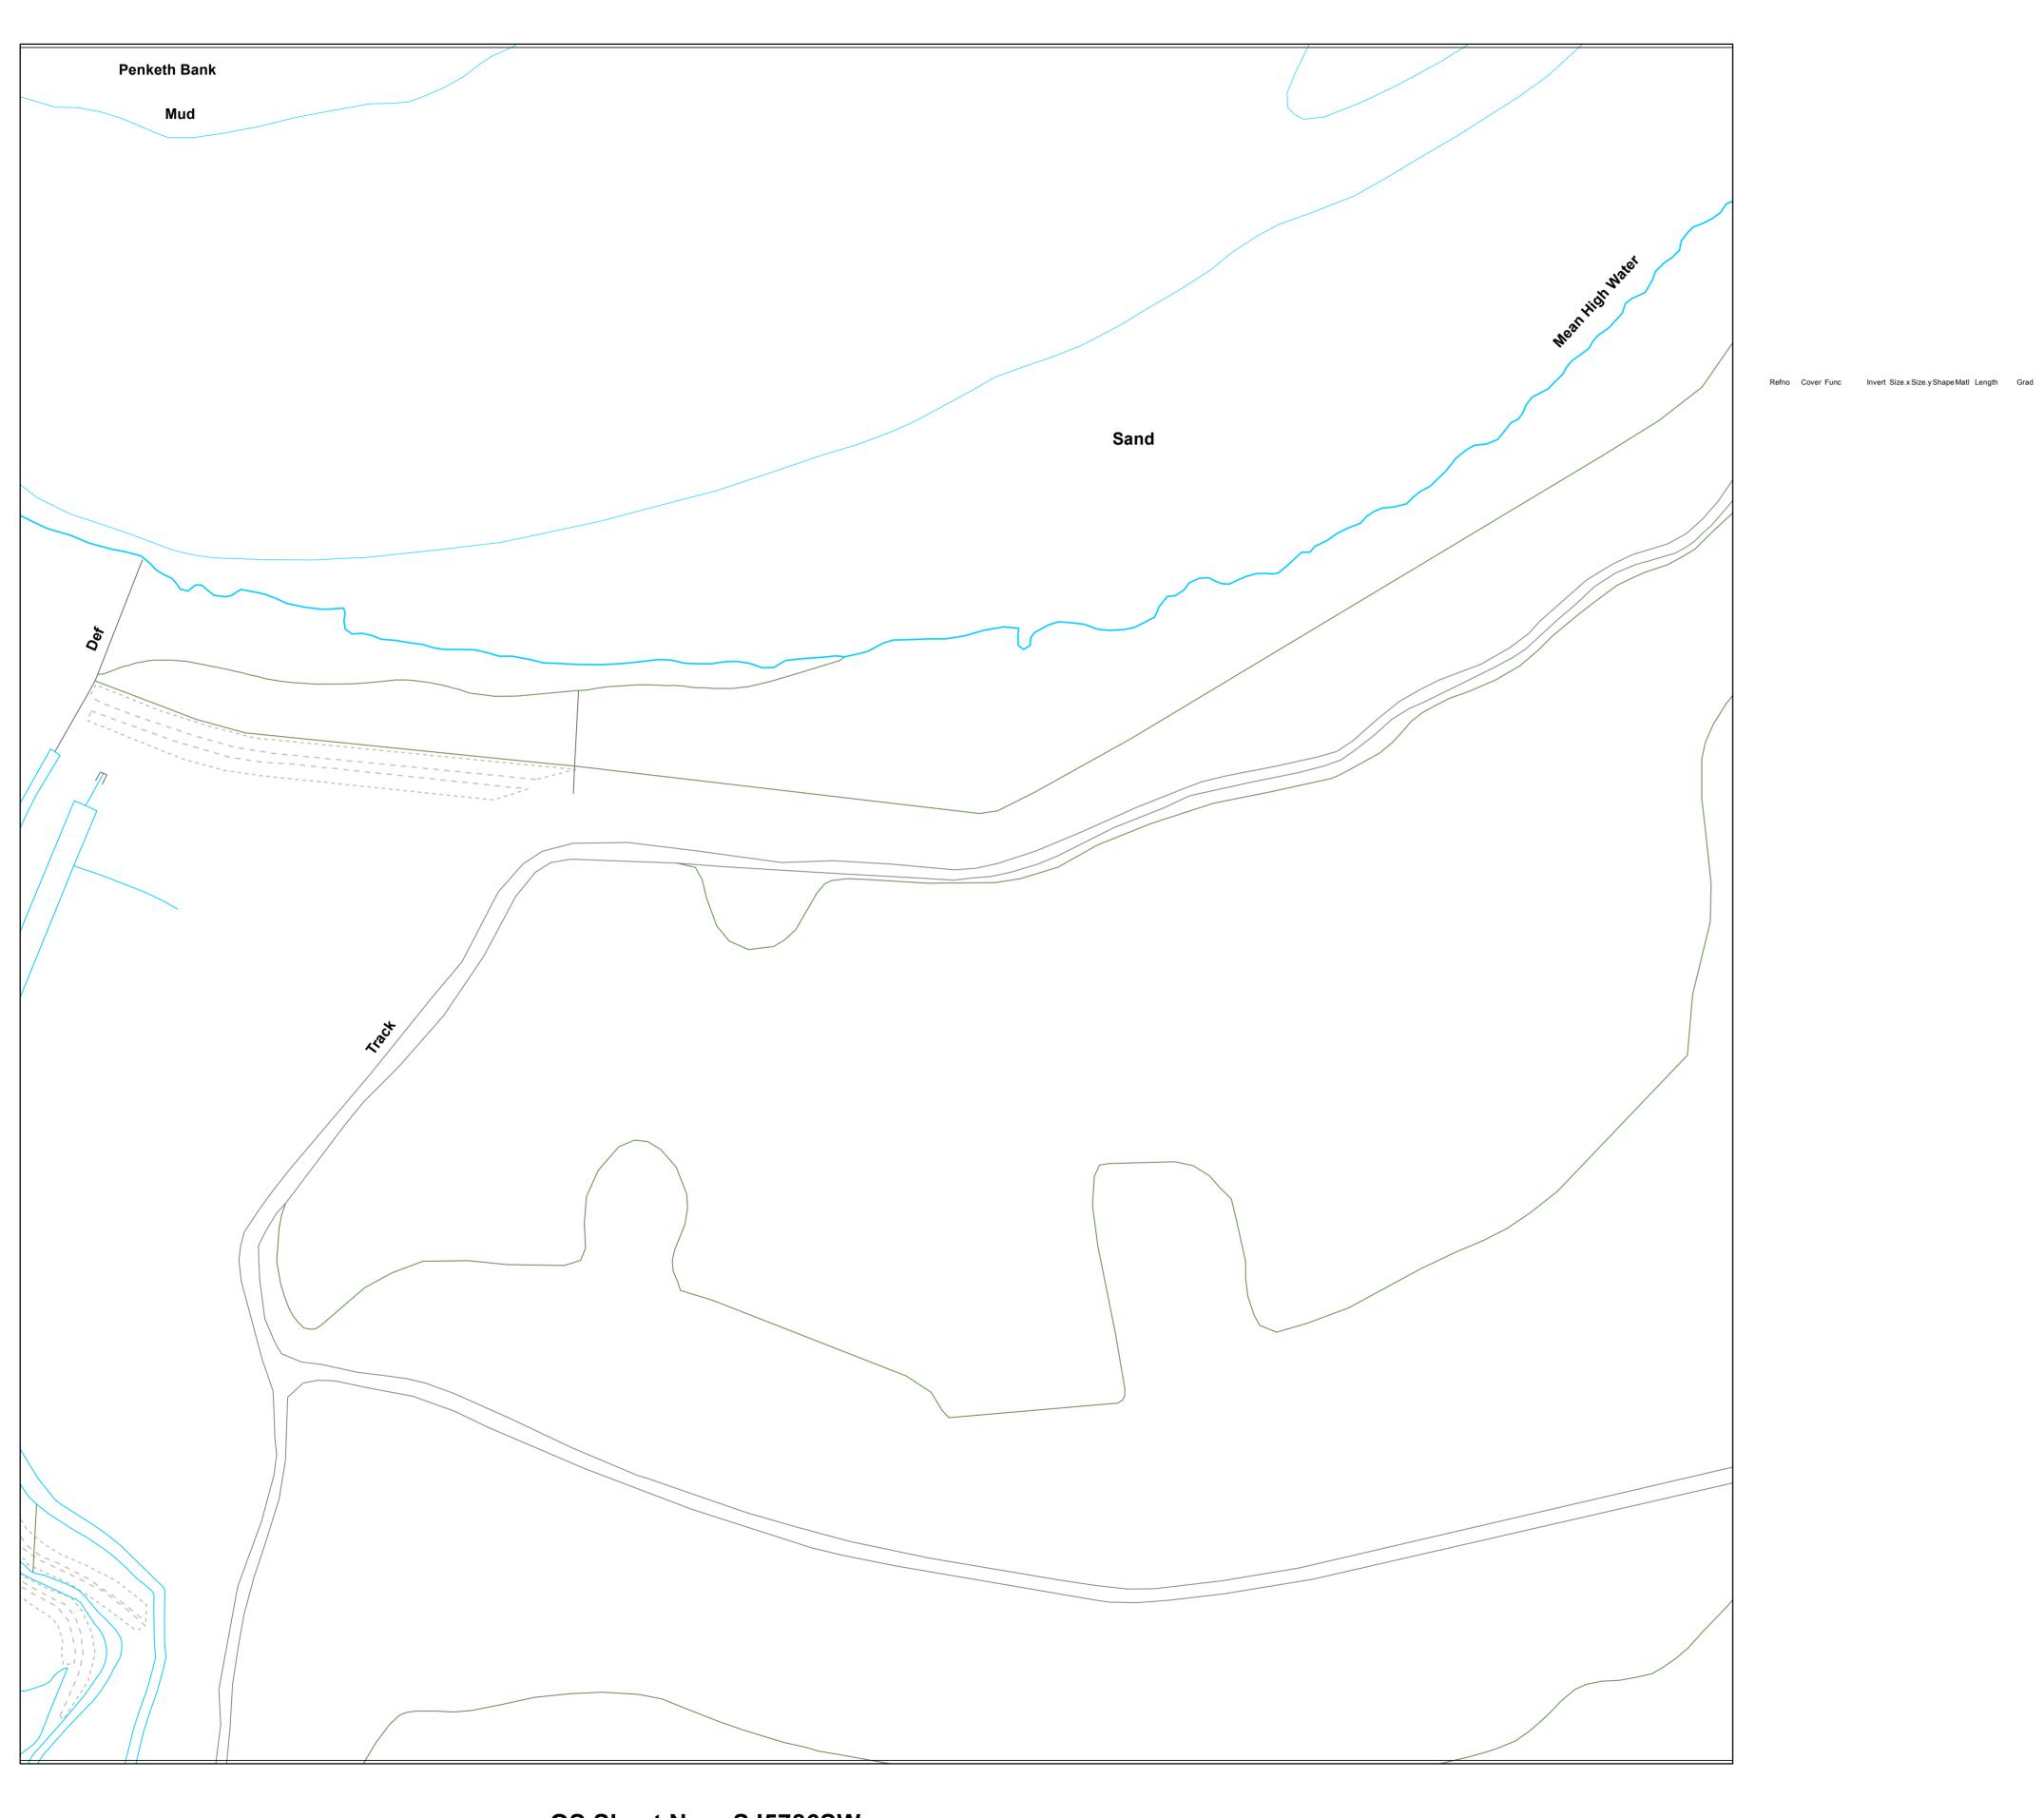
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SEWER RECORDS

OS Sheet No: SJ5786SE

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Foul Surface Combined Overflow — — — — — — — Rising Main, S104 Highway Drain, Private Foul Surface Combined WW Site Termination ——— Sludge Main, Public — 느 - Sludge Main, Private — ► – Sludge Main, S104 Non Return Valve ABANDONED PIPE Extent of Survey → MainSewer 🎳 💎 Flow Meter Rising Main → - - Highway Drain Sludge Main Head of System ● Hydrobrake/Vortex Inspection Chamber 🐼 🖎 બ Catchpit Contaminated Surface Water WW Pumping Station Sludge Pumping Station → i→ Sewer Overflow 🗂 🗂 🗂 TJunction/Saddle OilInterceptor √c √c Valve Chamber Washout Chamber 🞳 🧬 🔓 DropShaft WW Treatment Works ST Septic Tank Network Storage Tank 💞 🔐 💕 Orifice Plate O O Vortex Chamber O O O Blind Manhole Foul Surface Combined Overflow Screen Chamber CK Control Kiosk P Discharge Point Unspecified → ← → Outfall LEGEND MANHOLE FUNCTION FO Foul SW Surface Water CO Combined OV Overflow **SEWER SHAPE** CI Circular TR Trapezoidal EG Egg OV Oval FT Flat Top HO HorseShoe RE Rectangular UN Unspecified SQ Square SEWER MATERIAL DI Ductile Iron AC Asbestos Cement PVC Polyvinyl Chloride BR Brick PE Polyethylene RP Reinforced Plastic Matrix CO Concrete CSB Concrete Segment Bolted CSU Concrete Segment Unbolted PF Pitch Fibre CC Concrete Box Culverted PSC Plastic/Steel Composite MAC Masonry, Coursed GRC Glass Reinforced Concrete MAR Masonry, Random GRP Glass Reinforced Plastic U Unspecified The position of the underground apparatus shown on this plan is approximate only and is given in accordance with the best information currently available. United Utilities Water will not accept liability for any loss or damage caused by the actual position being different from those shown. Crown copyright and database rights [2016] Ordnance Survey 100022432. OS Sheet No: SJ5786SW

WASTE WATER SYMBOLOGY

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Scale: 1:1250 Date: 22/03/2018

0 Nodes Sheet 1 of 1

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SEWER RECORDS

OS Sheet No: SJ5786SW


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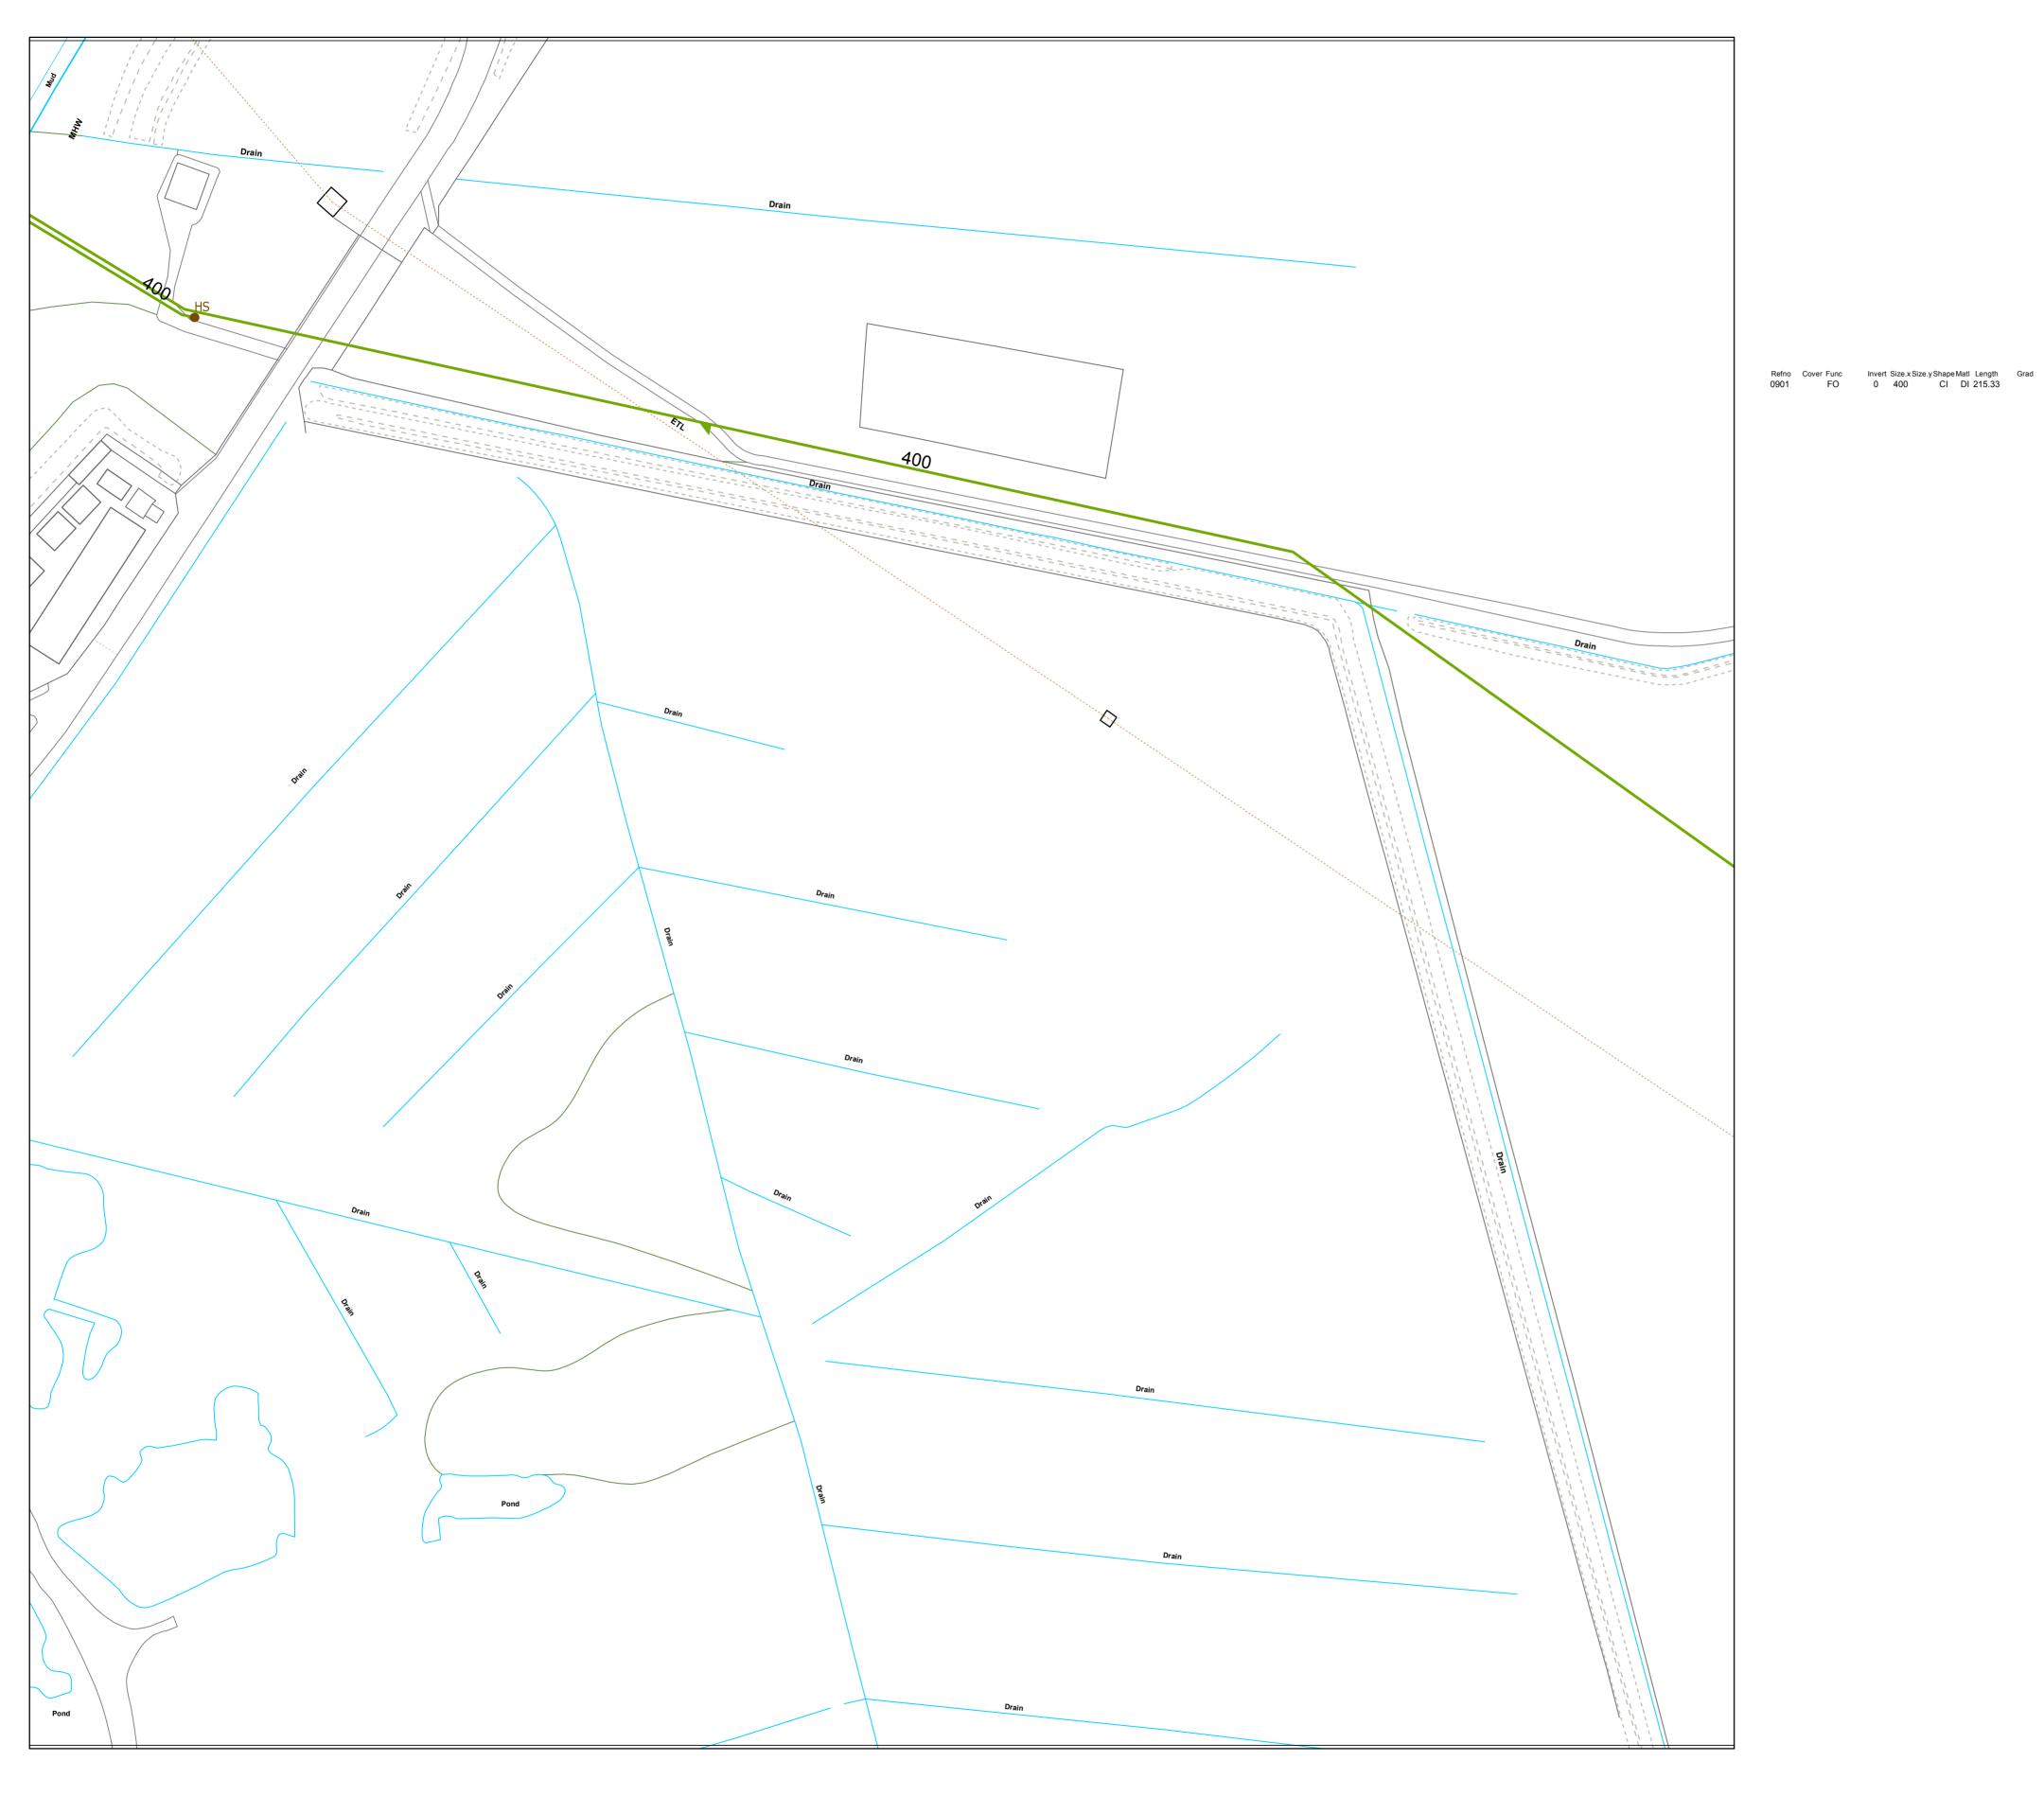
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— — — — — — — Rising Main, S104 Highway Drain, Private Foul Surface Combined WW Site Termination ——— Sludge Main, Public — 🛌 - Sludge Main, Private — ► – Sludge Main, S104 Non Return Valve ABANDONED PIPE Extent of Survey → MainSewer Rising Main → - - Highway Drain Sludge Main 🎳 🎳 Head of System Hydrobrake/Vortex Inspection Chamber 🖎 🖎 🖎 Catchpit Contaminated Surface Water WW Pumping Station Sludge Pumping Station → i→ Sewer Overflow 🗂 🗂 🖰 TJunction/Saddle oilInterceptor vo vo Valve Chamber Washout Chamber 🖺 🧬 opshaft WW Treatment Works ST Septic Tank Network Storage Tank 💞 🔐 💕 Orifice Plate O O Vortex Chamber O O O Blind Manhole Foul Surface Combined Overflow Screen Chamber CK Control Kiosk P Discharge Point Unspecified → ← → Outfall LEGEND MANHOLE FUNCTION FO Foul SW Surface Water CO Combined OV Overflow **SEWER SHAPE** CI Circular TR Trapezoidal EG Egg OV Oval FT Flat Top RE Rectangular SQ Square SEWER MATERIAL DI Ductile Iron AC Asbestos Cement PVC Polyvinyl Chloride PE Polyethylene RP Reinforced Plastic Matrix CO Concrete CSB Concrete Segment Bolted CSU Concrete Segment Unbolted PF Pitch Fibre CC Concrete Box Culverted PSC Plastic/Steel Composite MAC Masonry, Coursed GRC Glass Reinforced Concrete MAR Masonry, Random GRP Glass Reinforced Plastic U Unspecified copyright and database rights [2016] Ordnance Survey 100022432.

WASTE WATER SYMBOLOGY

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Foul Surface Combined Overflow

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> OS Sheet No: SJ5986NW Scale: 1:1250 Date: 22/03/2018


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OS Sheet No: SJ5986NW
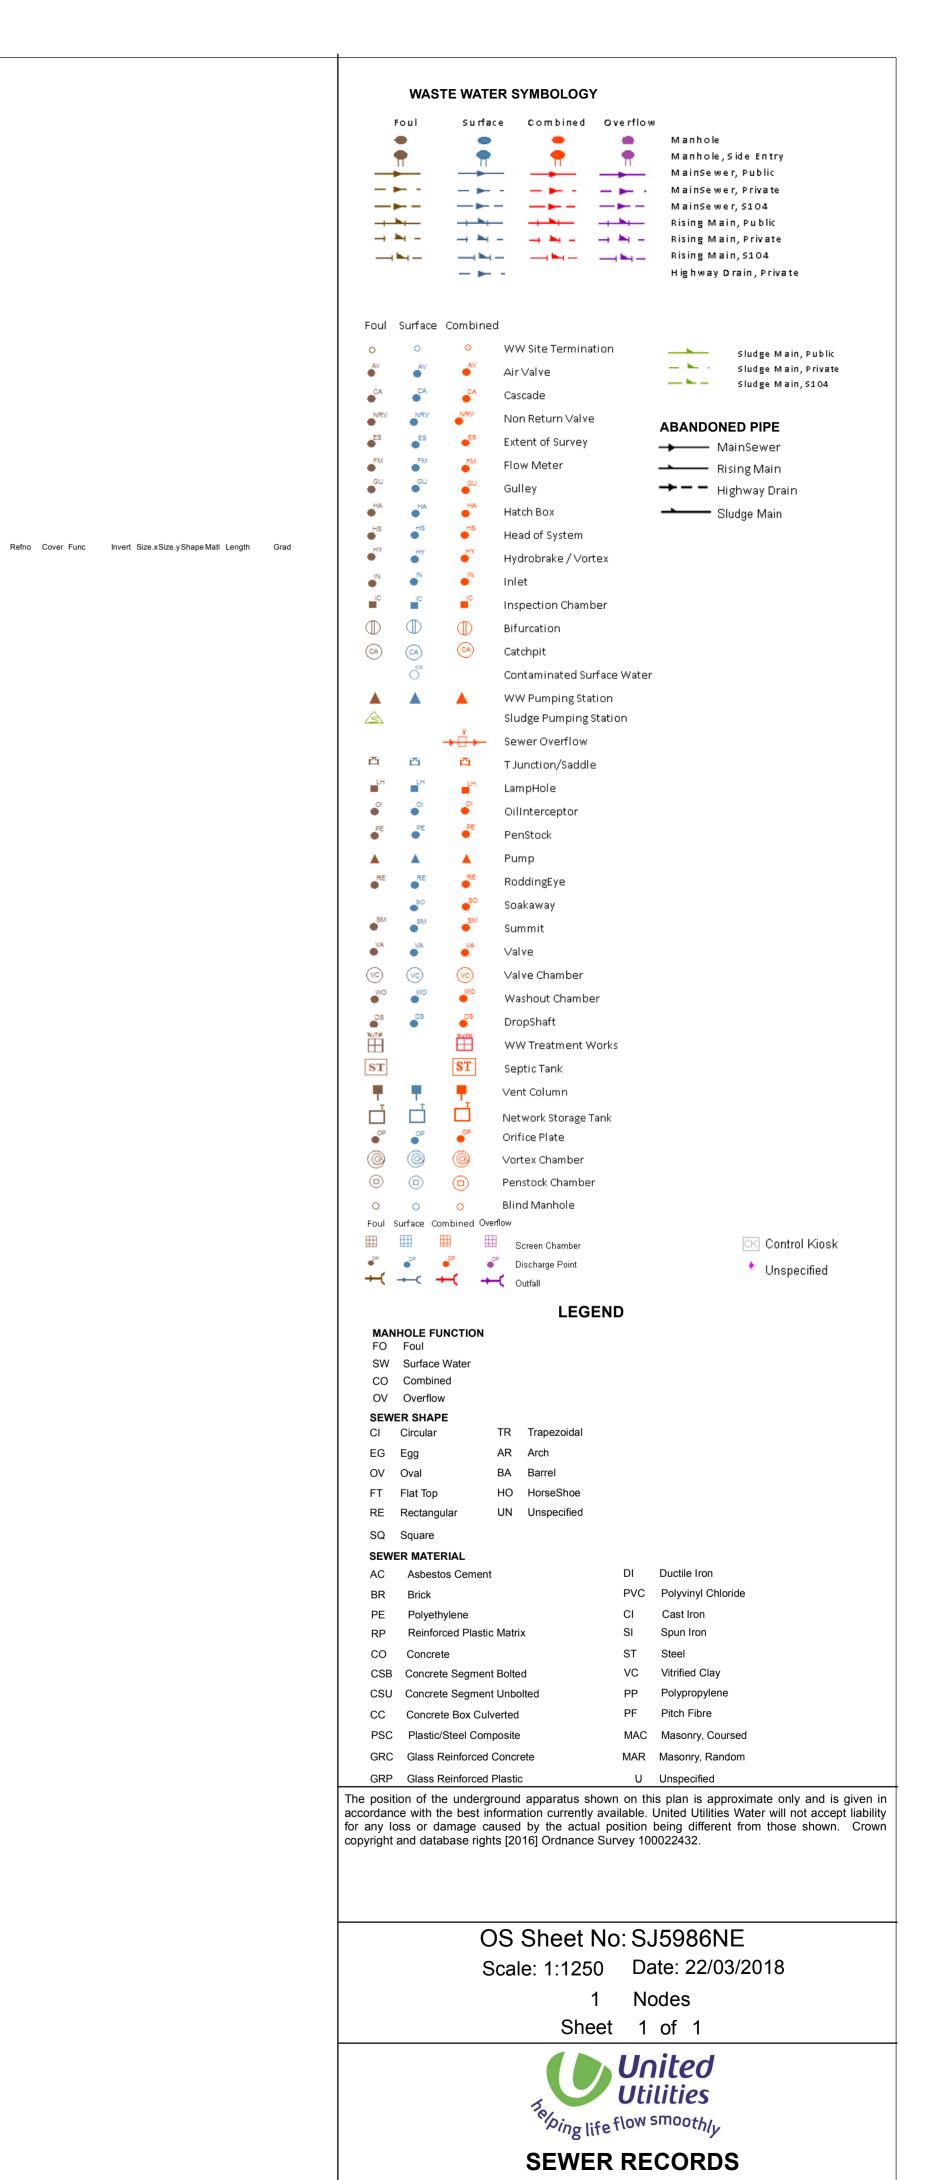
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Foul Surface Combined O WW Site Termination ——— Sludge Main, Public — 느 - Sludge Main, Private — 🛰 — Sludge Main, S104 Non Return Valve **ABANDONED PIPE** Extent of Survey → MainSewer Rising Main → - - Highway Drain ------ Sludge Main Head of System ● Hydrobrake/Vortex Inspection Chamber 🖎 🖎 🥝 Catchpit Contaminated Surface Water WW Pumping Station Sludge Pumping Station → i→ Sewer Overflow 🗂 🗂 🗂 TJunction/Saddle OilInterceptor vo Valve Chamber Washout Chamber WW Treatment Works Septic Tank Network Storage Tank 💞 🔐 💕 Orifice Plate O O O Vortex Chamber O O O Blind Manhole Foul Surface Combined Overflow Screen Chamber CK Control Kiosk P Discharge Point Unspecified → ← → Outfall LEGEND MANHOLE FUNCTION FO Foul SW Surface Water CO Combined OV Overflow **SEWER SHAPE** CI Circular TR Trapezoidal EG Egg AR Arch OV Oval FT Flat Top HO HorseShoe RE Rectangular SQ Square SEWER MATERIAL DI Ductile Iron AC Asbestos Cement PVC Polyvinyl Chloride PE Polyethylene RP Reinforced Plastic Matrix CO Concrete CSB Concrete Segment Bolted CSU Concrete Segment Unbolted Pitch Fibre CC Concrete Box Culverted PSC Plastic/Steel Composite MAC Masonry, Coursed GRC Glass Reinforced Concrete MAR Masonry, Random GRP Glass Reinforced Plastic U Unspecified

WASTE WATER SYMBOLOGY

Surface Combined Overflow

— Mules — Mules — Mules Rising Main, S104

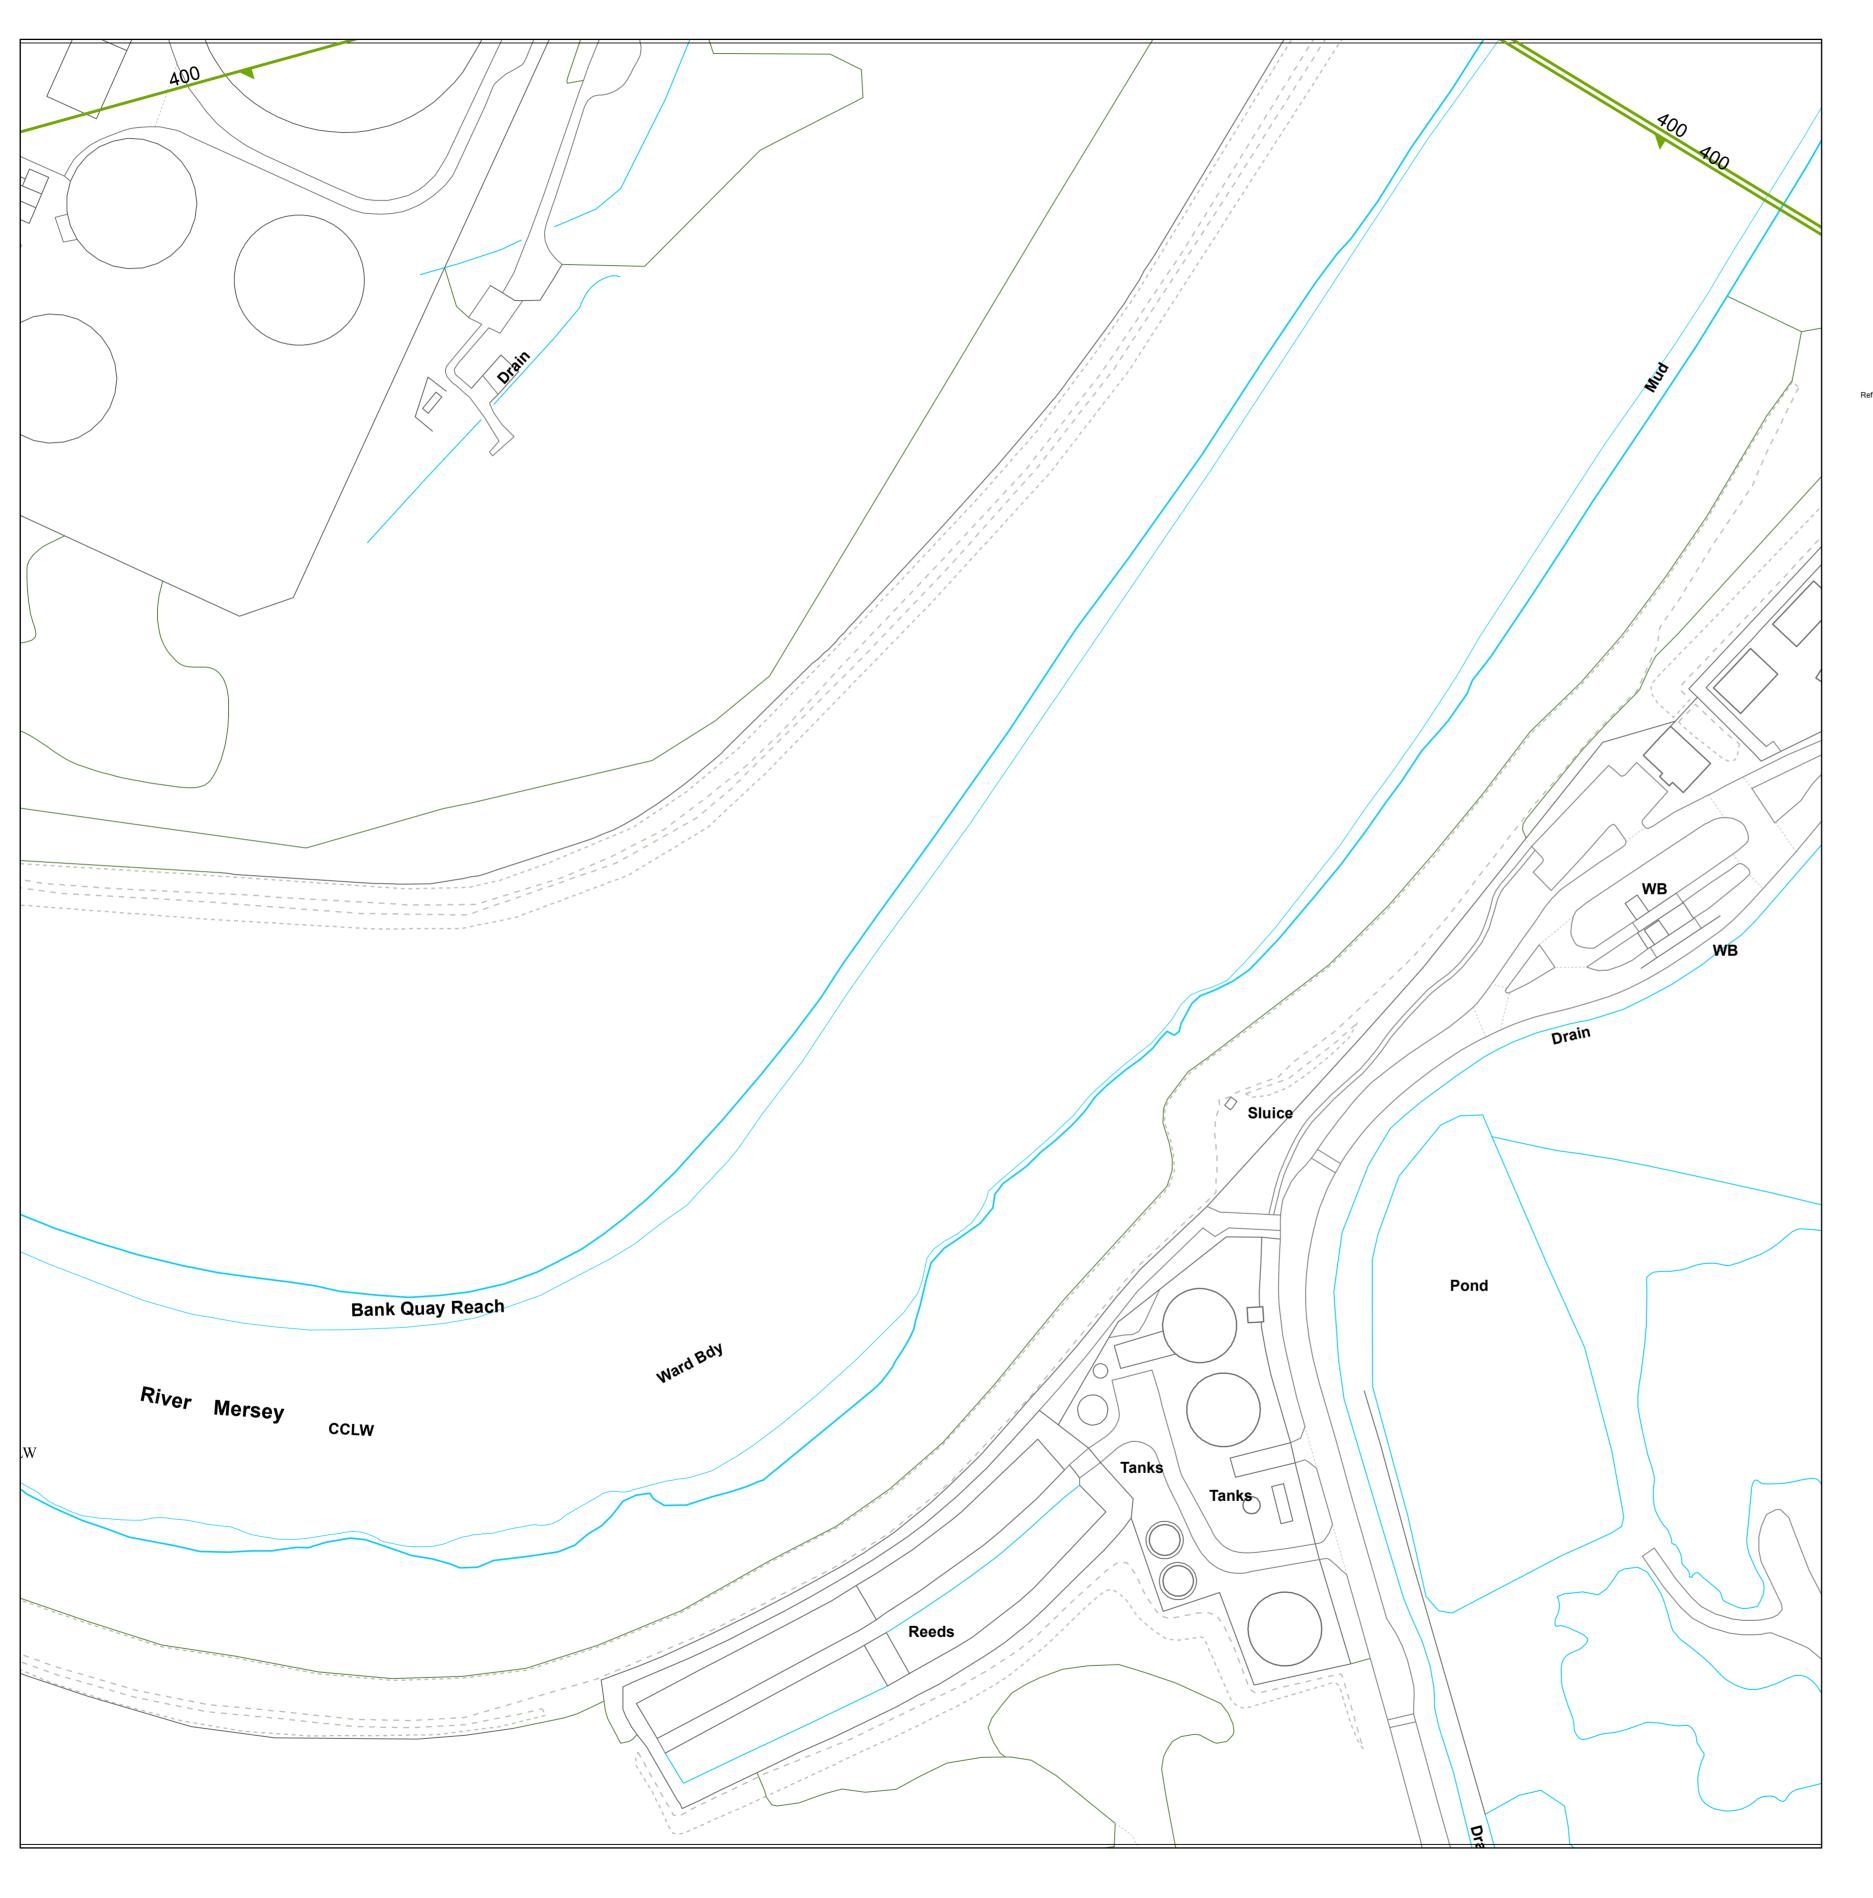Highway Drain, Private

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OS Sheet No: SJ5886NE

Scale: 1:1250 Date: 22/03/2018

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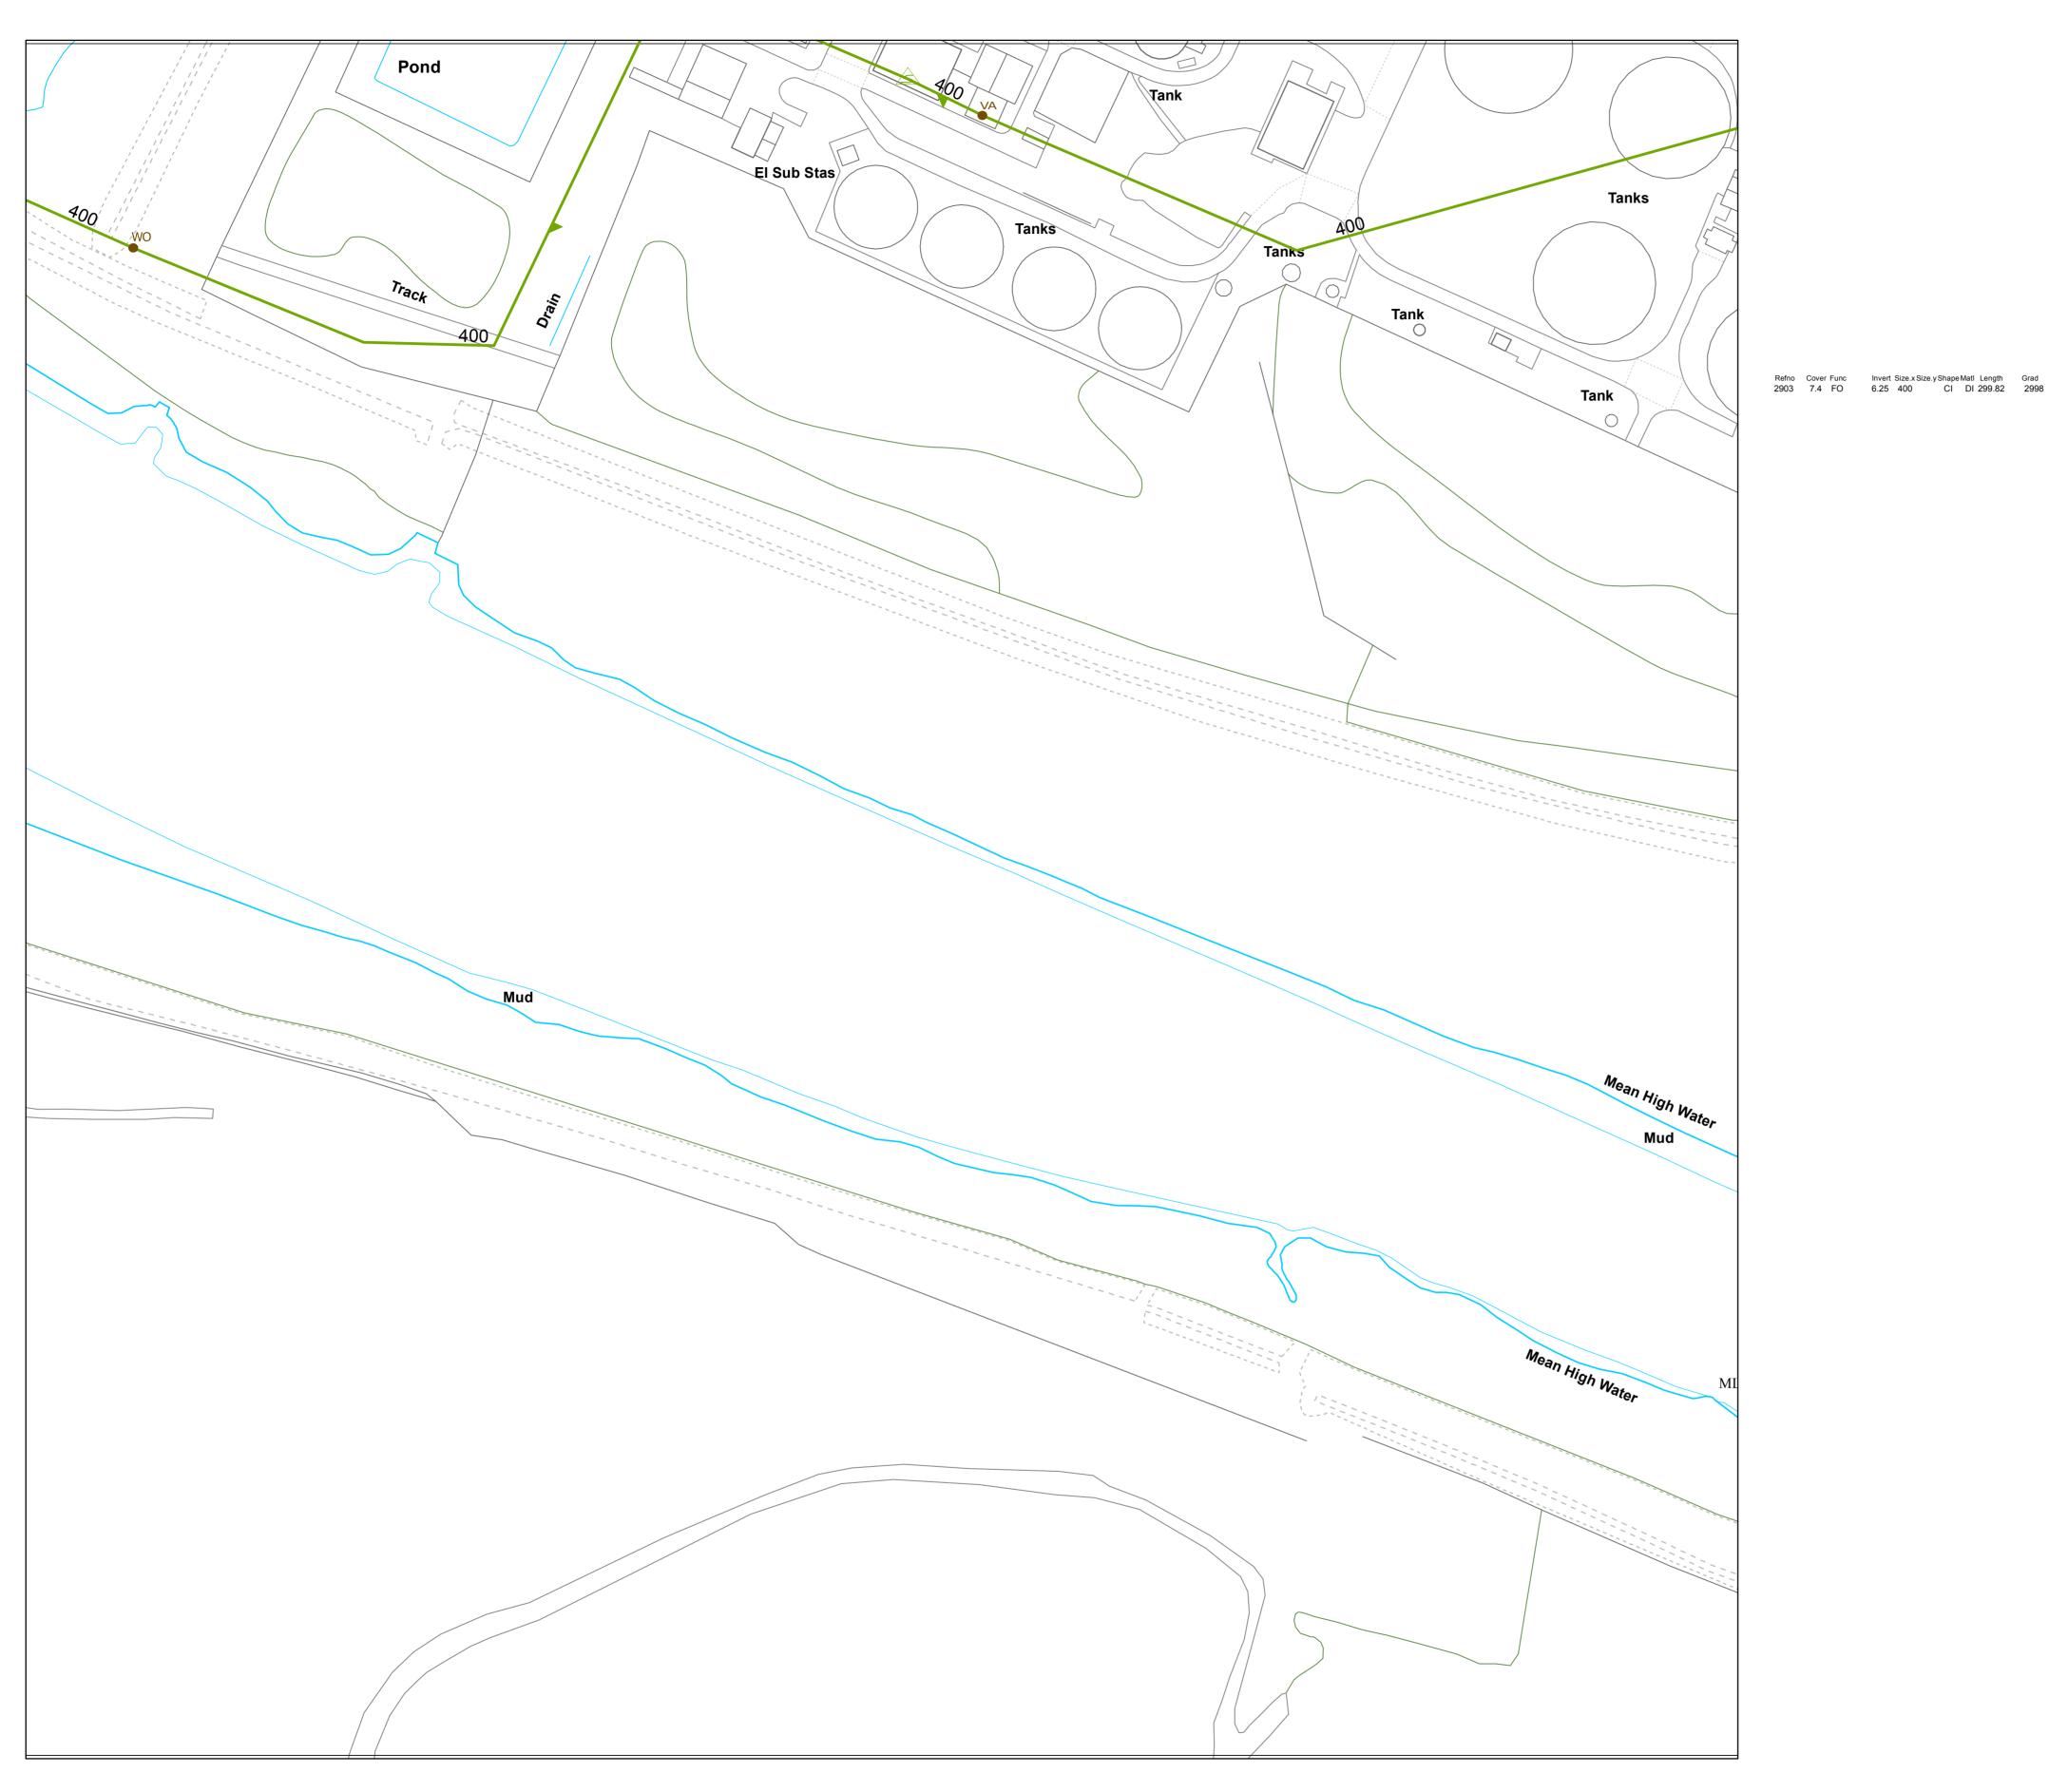
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SEWER RECORDS


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OS Sheet No: SJ5886NW

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WW Site Termination ——— Sludge Main, Public — 🛌 - Sludge Main, Private — ► – Sludge Main, S104 Non Return Valve **ABANDONED PIPE** Extent of Survey → MainSewer Rising Main → - - Highway Drain → Sludge Main Head of System Hydrobrake / Vortex Inspection Chamber Contaminated Surface Water WW Pumping Station Sludge Pumping Station → i→ Sewer Overflow 🗂 🗂 🖰 TJunction/Saddle √c ∨alve Chamber Washout Chamber DropShaft WW Treatment Works Network Storage Tank Orifice Plate Vortex Chamber O O O Blind Manhole Foul Surface Combined Overflow Screen Chamber CK Control Kiosk P Discharge Point Unspecified → ← → Outfall LEGEND MANHOLE FUNCTION FO Foul SW Surface Water CO Combined OV Overflow **SEWER SHAPE** CI Circular TR Trapezoidal EG Egg AR Arch OV Oval FT Flat Top HO HorseShoe RE Rectangular UN Unspecified SQ Square SEWER MATERIAL DI Ductile Iron AC Asbestos Cement PVC Polyvinyl Chloride PE Polyethylene RP Reinforced Plastic Matrix CO Concrete VC Vitrified Clay CSB Concrete Segment Bolted CSU Concrete Segment Unbolted PF Pitch Fibre CC Concrete Box Culverted PSC Plastic/Steel Composite MAC Masonry, Coursed GRC Glass Reinforced Concrete MAR Masonry, Random GRP Glass Reinforced Plastic U Unspecified

WASTE WATER SYMBOLOGY

Foul Surface Combined

Surface Combined Overflow

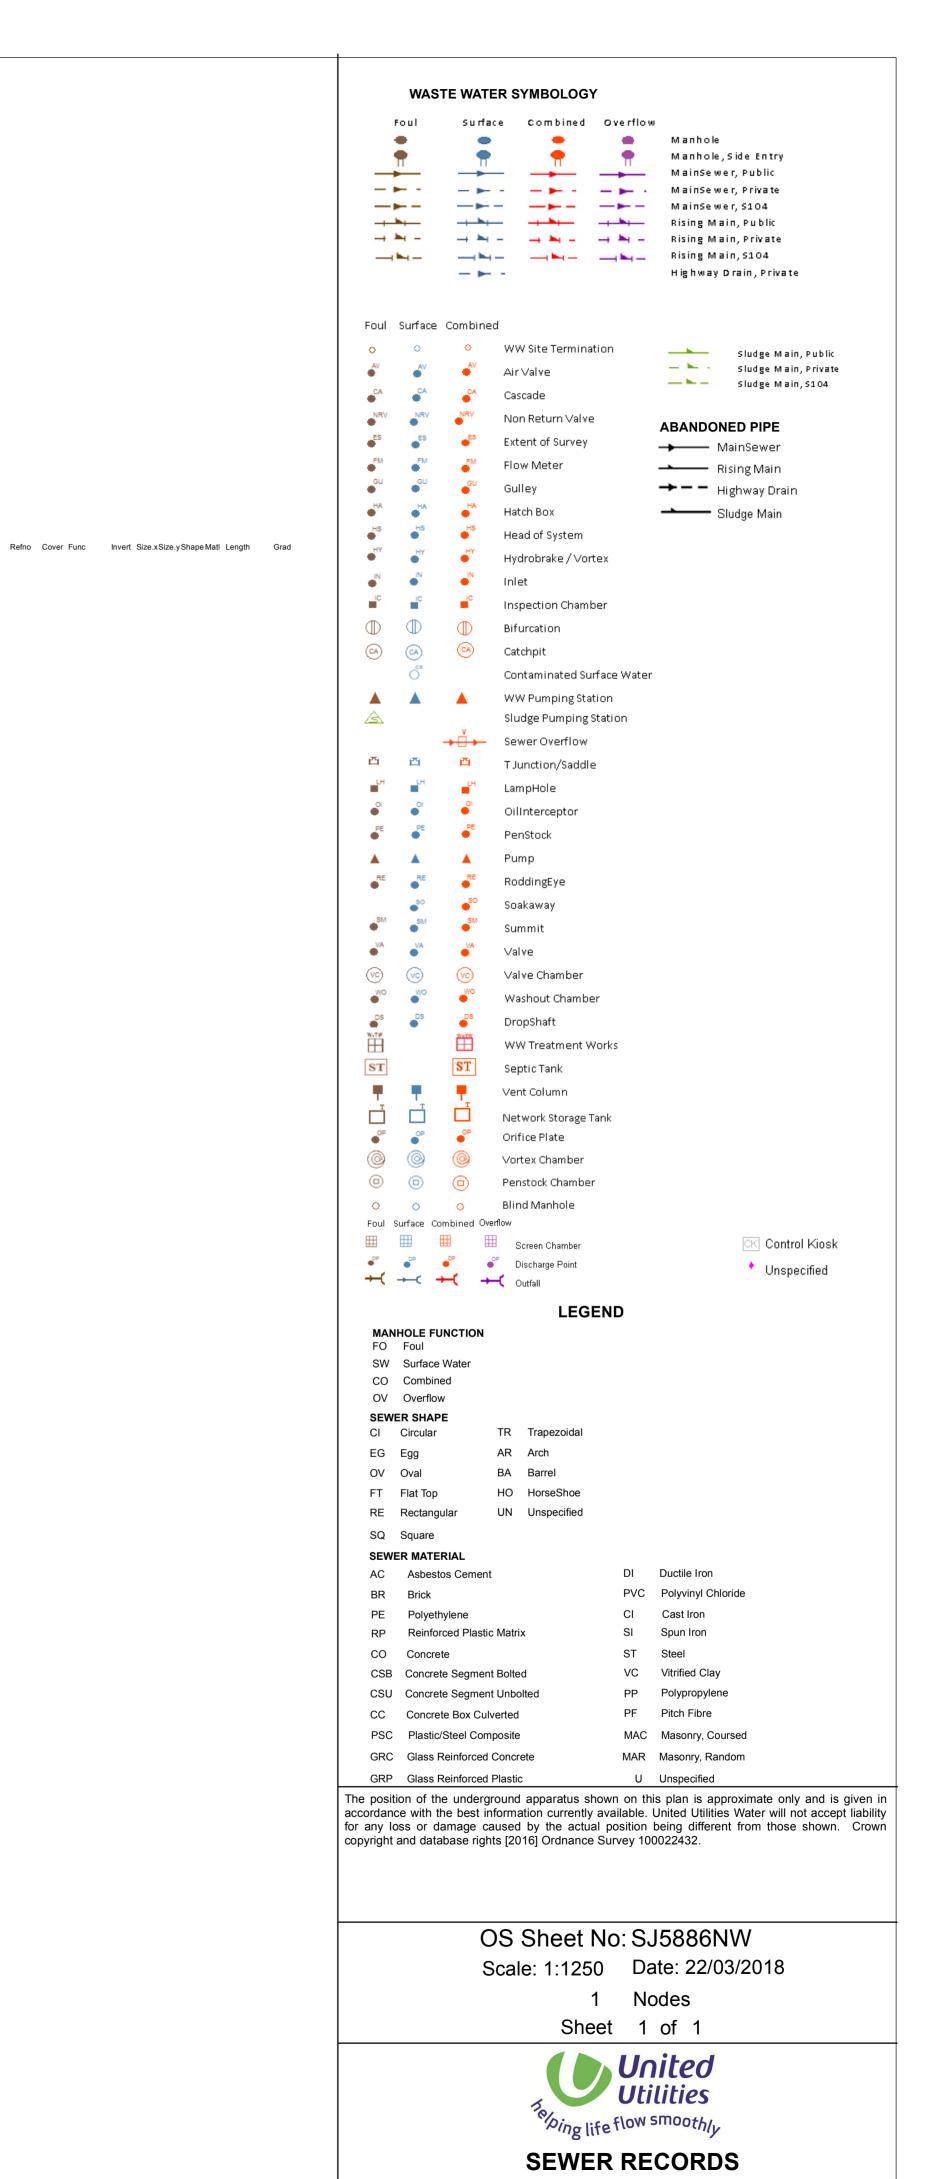Highway Drain, Private

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Scale: 1:1250 Date: 22/03/2018

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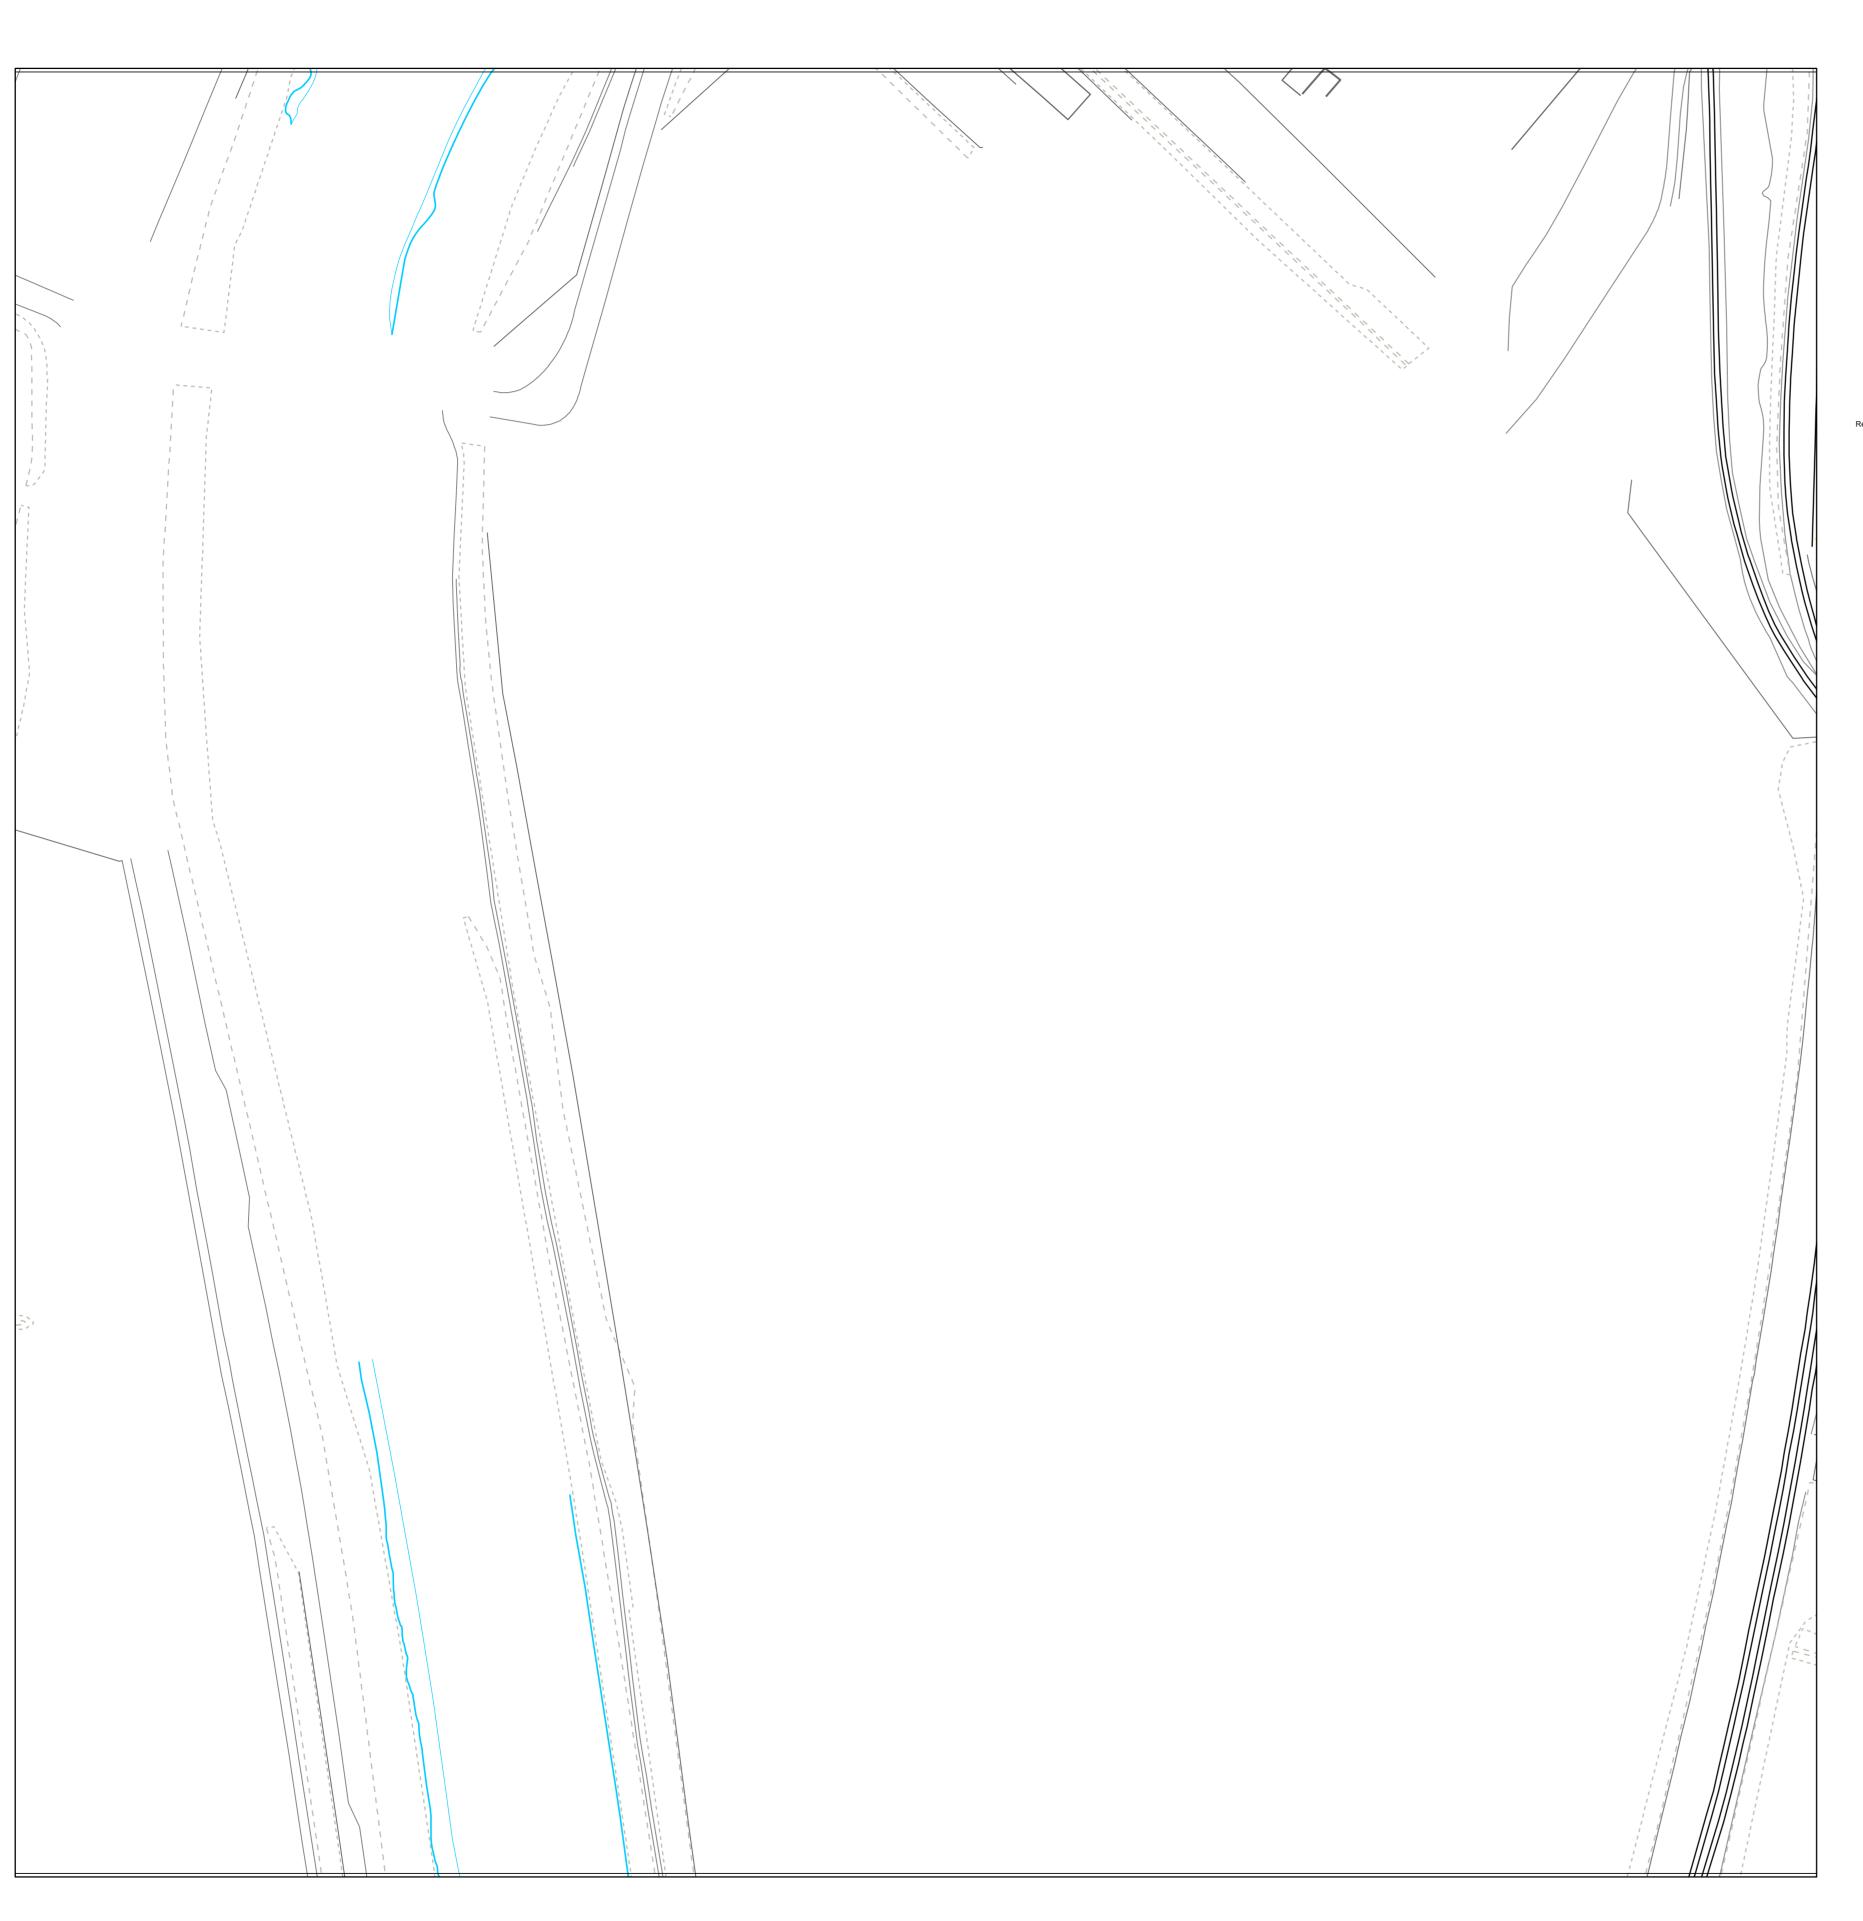
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— Main, S104 Highway Drain, Private Foul Surface Combined WW Site Termination ——— Sludge Main, Public — 🛌 - Sludge Main, Private 🞳 🞳 🞳 Air Valve — 🛰 — Sludge Main, S104 💞 🚰 Cascade Non Return Valve ABANDONED PIPE 🎳 🞳 🎳 Extent of Survey → MainSewer 🎳 🎳 Flow Meter Rising Main → - - Highway Drain Sludge Main 🞳 🎳 Head of System ● Hydrobrake/Vortex 🖺 🖺 Inspection Chamber 🖎 🐼 👄 Catchpit Contaminated Surface Water WW Pumping Station Sludge Pumping Station → Sewer Overflow 🗂 🗂 🗂 T Junction/Saddle OilInterceptor √c √c Valve Chamber ● Washout Chamber 🞳 🧬 🔓 DropShaft WW Treatment Works Septic Tank Vent Column Network Storage Tank 💞 🔐 💕 Orifice Plate O O Vortex Chamber O O O Blind Manhole Foul Surface Combined Overflow Screen Chamber CK Control Kiosk 🎳 📭 💕 Discharge Point Unspecified → ← → Outfall **LEGEND** MANHOLE FUNCTION FO Foul SW Surface Water CO Combined OV Overflow **SEWER SHAPE** CI Circular TR Trapezoidal AR Arch EG Egg OV Oval FT Flat Top HO HorseShoe RE Rectangular UN Unspecified SQ Square SEWER MATERIAL DI Ductile Iron AC Asbestos Cement PVC Polyvinyl Chloride BR Brick PE Polyethylene Cast Iron RP Reinforced Plastic Matrix Spun Iron CO Concrete VC Vitrified Clay CSB Concrete Segment Bolted CSU Concrete Segment Unbolted Polypropylene PF Pitch Fibre CC Concrete Box Culverted PSC Plastic/Steel Composite MAC Masonry, Coursed GRC Glass Reinforced Concrete MAR Masonry, Random GRP Glass Reinforced Plastic U Unspecified The position of the underground apparatus shown on this plan is approximate only and is given in accordance with the best information currently available. United Utilities Water will not accept liability

WASTE WATER SYMBOLOGY

Foul Surface Combined Overflow

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OS Sheet No: SJ5987SE

Scale: 1:1250 Date: 22/03/2018

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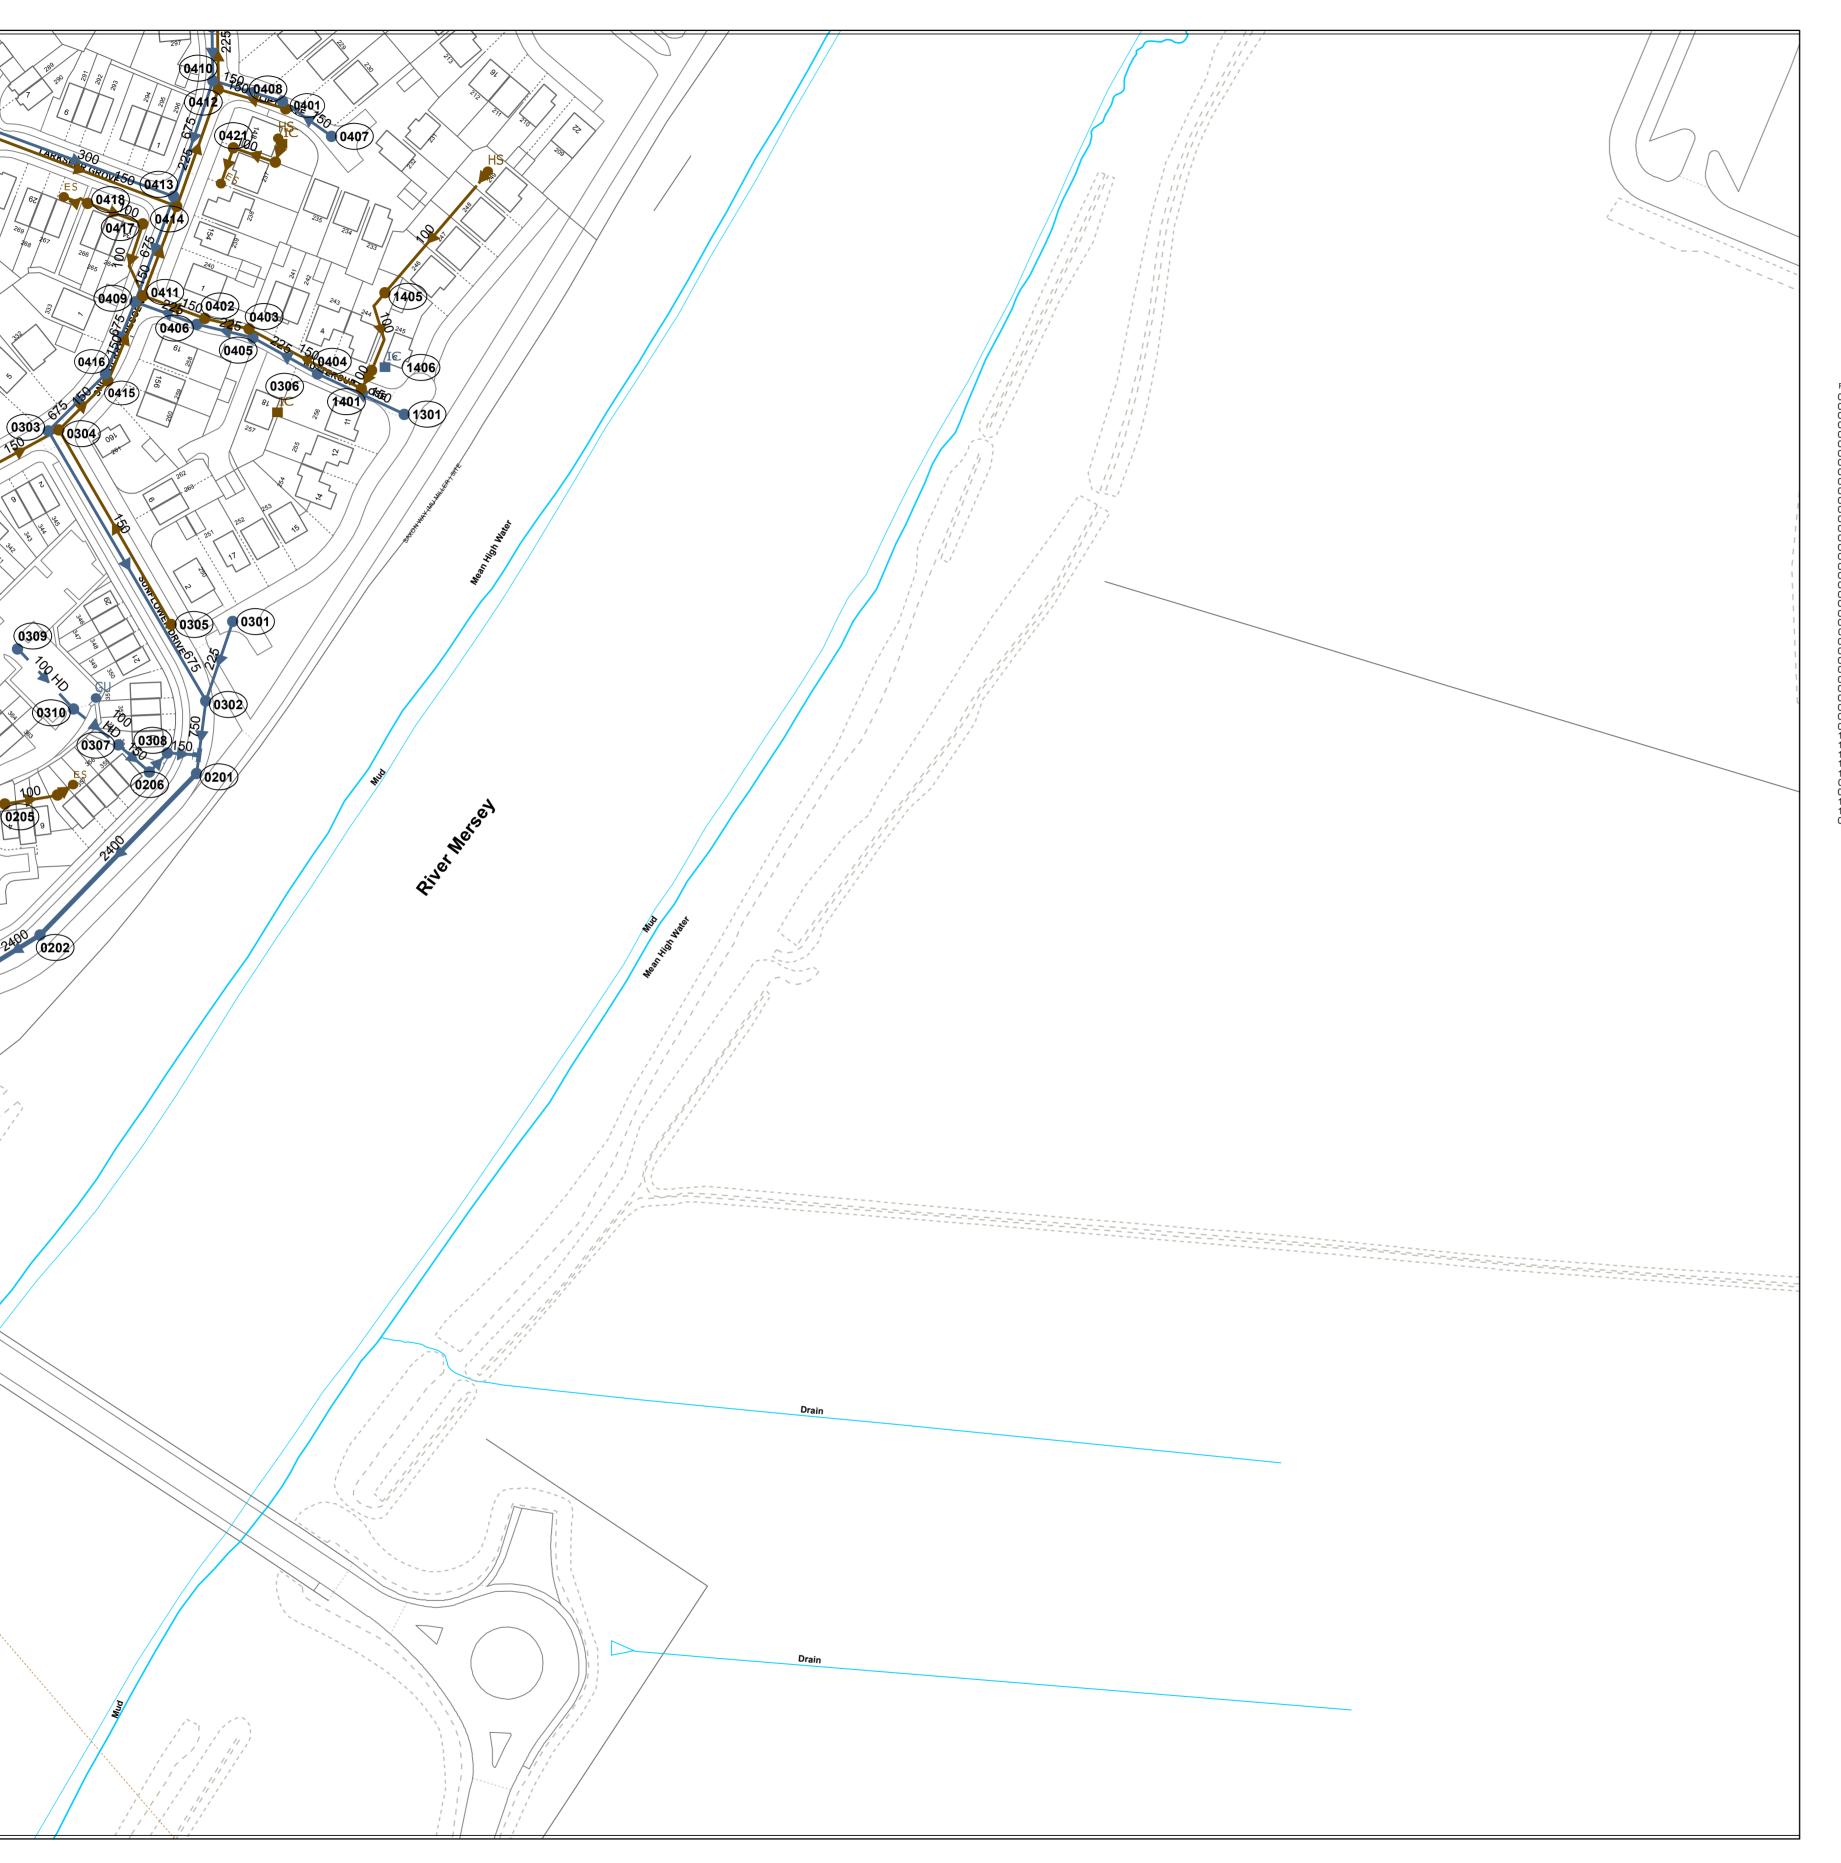
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SEWER RECORDS

OS Sheet No: SJ5987SE

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 0201
 9.82 SW

 0202
 9.9 SW

 0204
 9.8 FO

 0205
 SW

 0301
 10.3 SW

 0302
 10.1 SW

 0303
 9.87 SW

 0304
 9.85 FO

 0305
 10.43 FO

 0307
 SW

 0308
 SW

 0310
 SW

 0401
 9.8 FO

 0402
 9.69 FO

 0403
 9.79 FO

 0404
 10.07 SW

 0405
 9.82 SW

 0406
 9.74 SW

 0407
 9.71 SW

 0408
 9.78 SW

 0410
 9.66 SW

 0411
 9.65 FO

 0413
 9.65 SW

 0414
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 0415
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 0417
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 FO

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 8.61 150 CI VC 62.41 55 6.59 675 CI CO 33.96 566 7.29 150 CI VC 25.49 196 100 CI PVC 12.28

100 CI VC 39.05

accordance with the best information currently available. United Utilities Water will not accept liability for any loss or damage caused by the actual position being different from those shown. Crown copyright and database rights [2016] Ordnance Survey 100022432.

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WASTE WATER SYMBOLOGY

WW Site Termination

Non Return Valve

Extent of Survey

Head of System

WW Pumping Station

🗂 🗂 🖰 TJunction/Saddle

→ i→ Sewer Overflow

OilInterceptor

vc Valve Chamber

WW Treatment Works

Network Storage Tank

LEGEND

Septic Tank

Orifice Plate Vortex Chamber

TR Trapezoidal

HO HorseShoe

UN Unspecified

Washout Chamber

O O O Blind Manhole

Screen Chamber

P Discharge Point

→ ← → Outfall

MANHOLE FUNCTION

SW Surface Water CO Combined OV Overflow **SEWER SHAPE** CI Circular

FO Foul

EG Egg OV Oval FT Flat Top

RE Rectangular

AC Asbestos Cement

RP Reinforced Plastic Matrix

CSB Concrete Segment Bolted

CC Concrete Box Culverted PSC Plastic/Steel Composite

CSU Concrete Segment Unbolted

GRC Glass Reinforced Concrete

GRP Glass Reinforced Plastic

PE Polyethylene

CO Concrete

SQ Square SEWER MATERIAL

Foul Surface Combined Overflow

DropShaft

Hydrobrake / Vortex

Inspection Chamber

Contaminated Surface Water

Sludge Pumping Station

Foul Surface Combined

Surface Combined Overflow

Highway Drain, Private

ABANDONED PIPE

→ MainSewer Rising Main → - - Highway Drain Sludge Main

Sludge Main, Public — 🛌 - Sludge Main, Private — ► – Sludge Main, S104

CK Control Kiosk

Unspecified

OS Sheet No: SJ5987SW Scale: 1:1250 Date: 22/03/2018

> 46 Nodes Sheet 1 of 1

DI Ductile Iron

VC Vitrified Clay

PF Pitch Fibre

MAC Masonry, Coursed

MAR Masonry, Random

U Unspecified

PVC Polyvinyl Chloride


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APPENDIX D



APPENDIX E



IMPORTANT WARNING
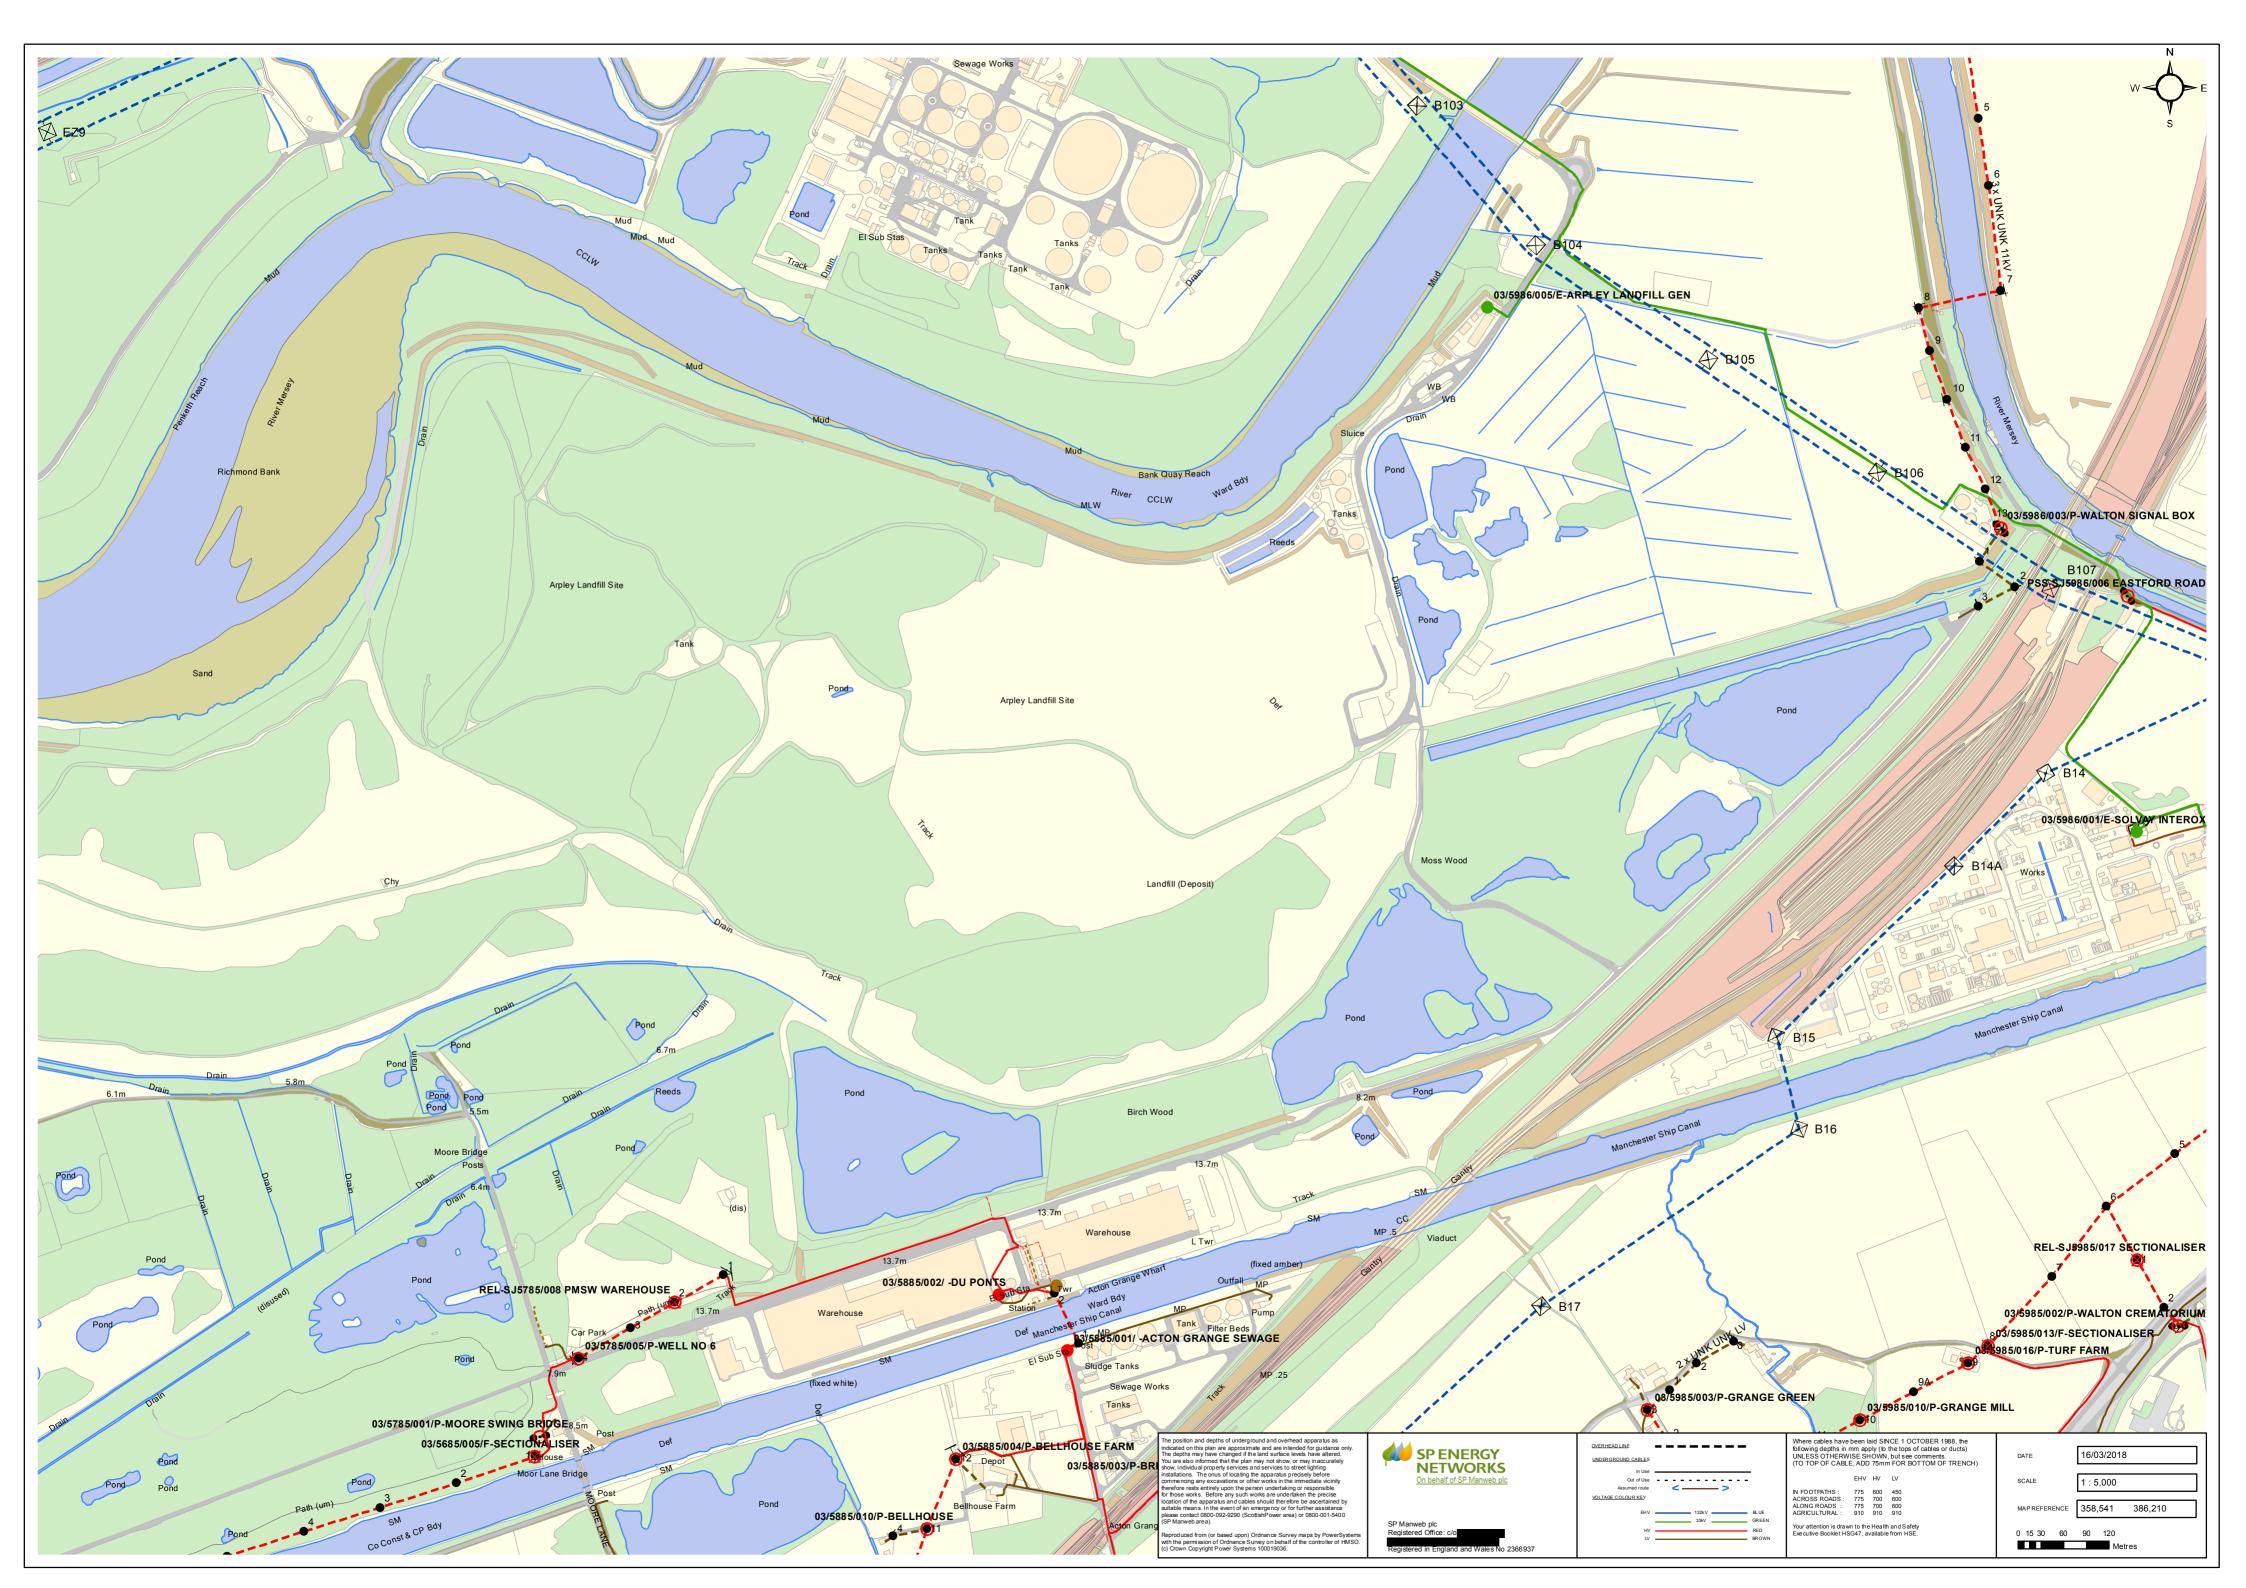
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Change Of State KEY TO BT SYMBOLS PCP DP Planned Inferred Planned DP Planned PCP Built

Planned Pole

Joint Box

+ X **▼ ■**

Split Coupling Duct Tee Planned Box Manhole Planned Manhole


Cabinet

Other proposed plant is shown using dashed lines.
BT Symbols not listed above maybe disregarded.
Existing BT Plant may not be recorded.

Map Reference : (centre) SJ5888386672 Easting/Northing : (centre) 358883,386672

BT Ref: VZE01152B

Issued: 15/03/2018 13:15:41

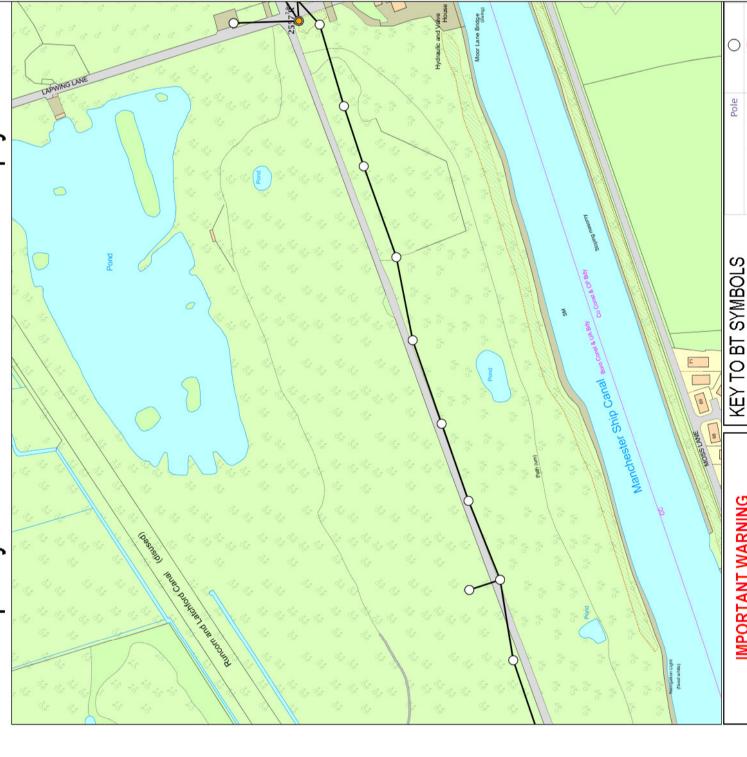

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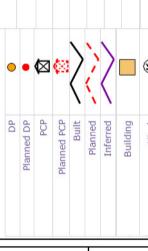
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Change Of State Split Coupling Duct Tee Planned Box Manhole Planned Manhole

Planned Pole


Joint Box

BT Ref: AEQ01264H

Other proposed plant is shown using dashed lines.
BY Symbols not listed above maybe disregarded.
Existing BY Plant may not be recorded.

Issued: 15/03/2018 13:26:42

Map Reference : (centre) SJ5754485404 Easting/Northing : (centre) 357544,385404

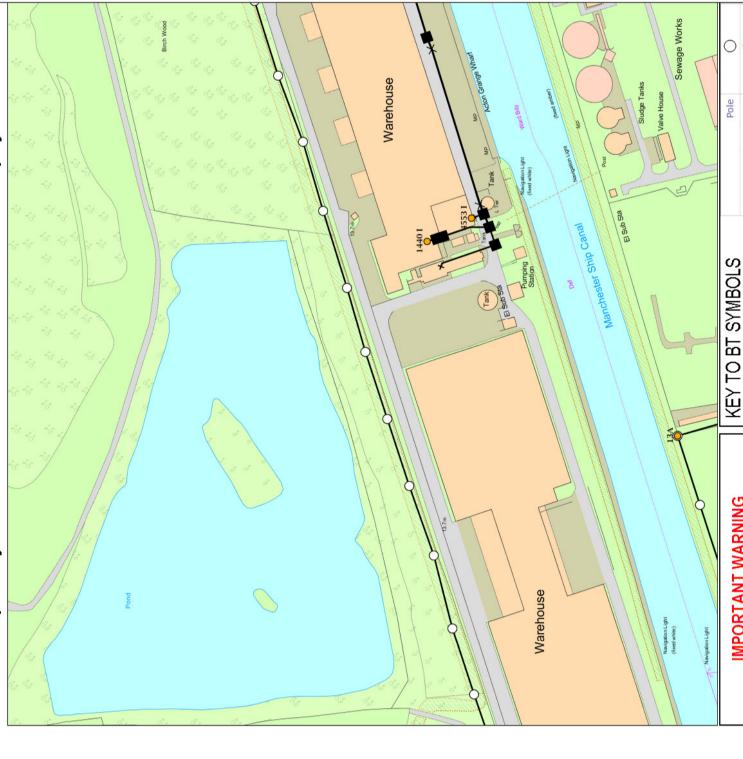


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Planned Pole Change Of State Split Coupling Duct Tee Planned Box Manhole Planned Manhole Joint Box PCP Planned Inferred Planned DP Planned PCP Built Building

X **◀ ■ ■**

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BT Ref : AJF01199C

Other proposed plant is shown using dashed lines BT Symbols not listed above maybe disregarded. Existing BT Plant may not be recorded.

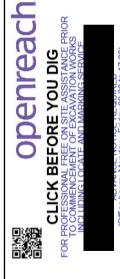Planned Cabinet

Hatchings

Map Reference : (centre) SJ5835085667 Easting/Northing : (centre) 358350,385667 Issued: 15/03/2018 13:19:16



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KEY TO BT SYMBOLS

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Planned Pole Joint Box Change Of State Split Coupling Duct Tee Planned Box Manhole Planned Manhole PCP DP Inferred Building Planned DP Planned PCP Built Planned

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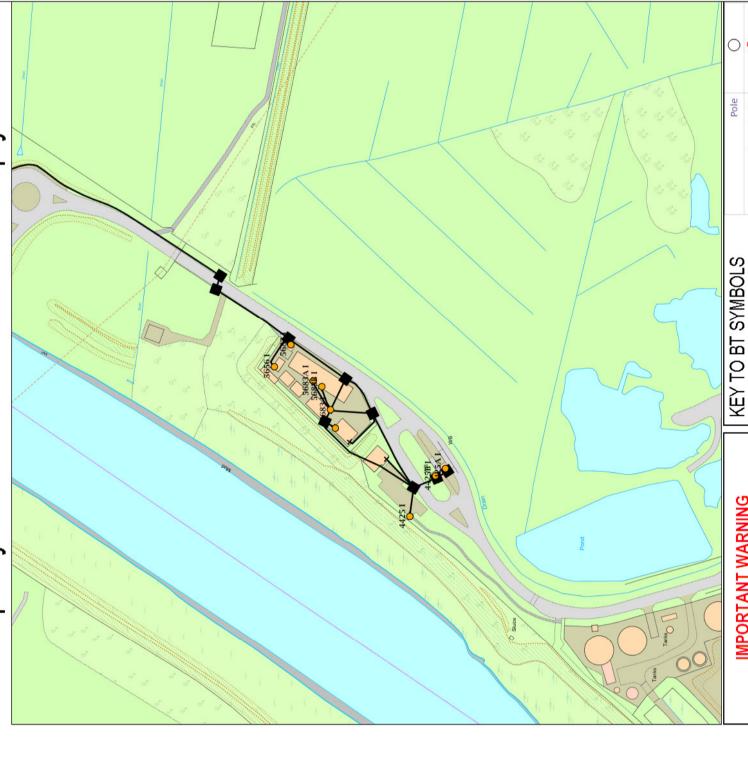
BT Ref: BNT01138V

Other proposed plant is shown using dashed lines.
BT Symbols not listed above maybe disregarded.
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Cabinet

Map Reference : (centre) SJ5924486758 Easting/Northing : (centre) 359244,386758

Issued: 15/03/2018 13:13:44



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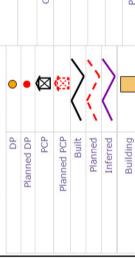
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C	Planned Cabinet	×
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	Manhole	>
	Planned Box	>
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+	Change Of State	፟፟⊠
	Joint Box	•
)	Plailled Pole	0

BT Ref: CRE01149W

Map Reference : (centre) SJ5902686808 Easting/Northing : (centre) 359026,386808

Issued: 15/03/2018 13:14:59



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Planned Cabinet
Other proposed plant is shown using dashed lines.
BT Symbols not listed above maybe disregarded.
Existing BT Plant may not be recorded.
Information valid at time of Joint Box Change Of State Split Coupling Duct Tee Planned Box Manhole Planned Manhole Cabinet PCP Planned Inferred Planned DP Planned PCP Built Building Hatchings BT Ref : IOU01191Y


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Planned Pole

Map Reference : (centre) SJ5792885586 Easting/Northing : (centre) 357928,385586

Issued: 15/03/2018 13:19:39



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Hatchings
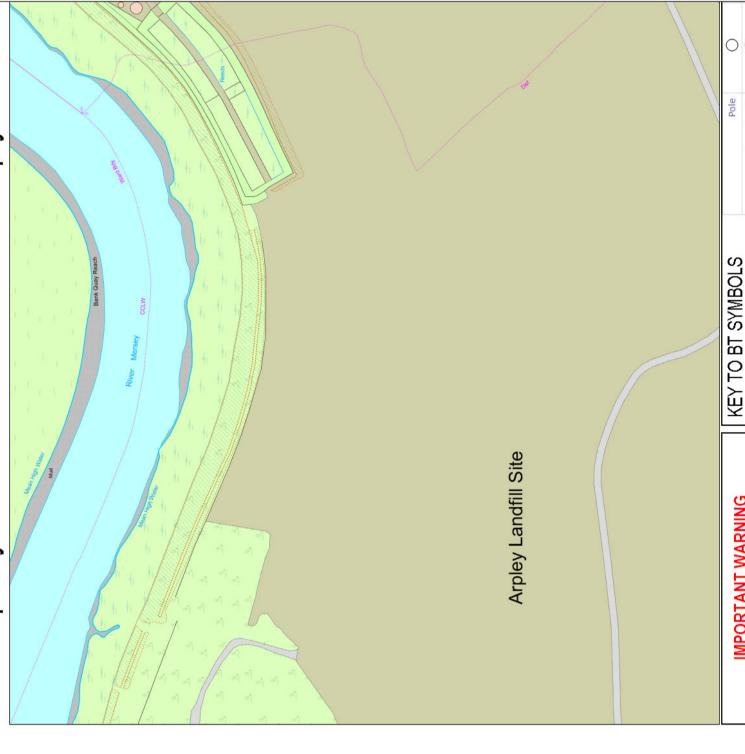
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Planned Pole Change Of State Split Coupling Duct Tee Planned Box Manhole Planned Manhole Joint Box PCP DP Planned Inferred Building Planned DP Planned PCP Built


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BT Ref: LFK01164T

Planned Cabinet
Other proposed plant is shown using dashed lines.
BT Symbols not listed above maybe disregarded.
Existing BT Plant may not be recorded.
Information valid at time of

Cabinet

Map Reference : (centre) SJ5855286460 Easting/Northing : (centre) 358552,386460 Issued: 15/03/2018 13:17:11

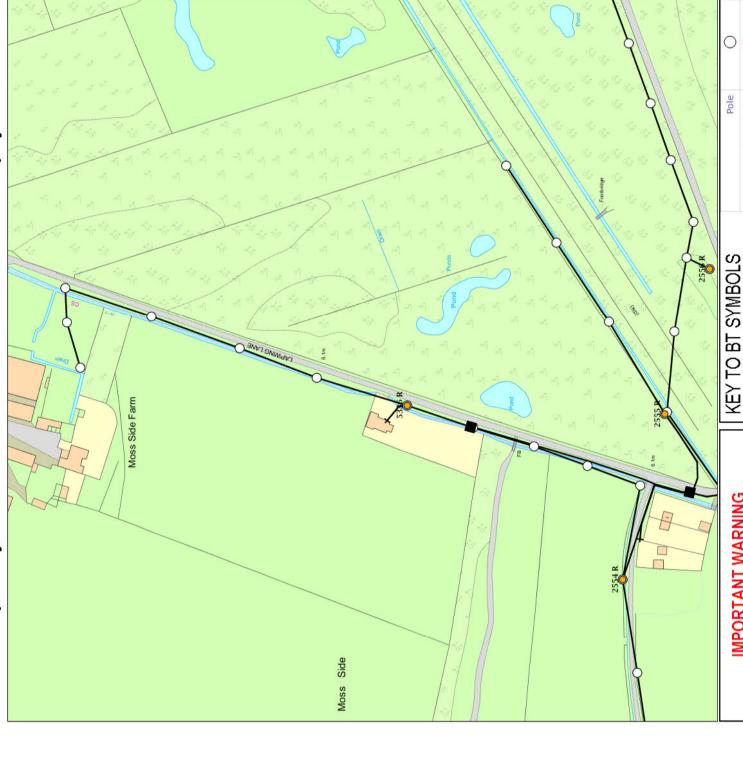

IMPORTANT WARNING


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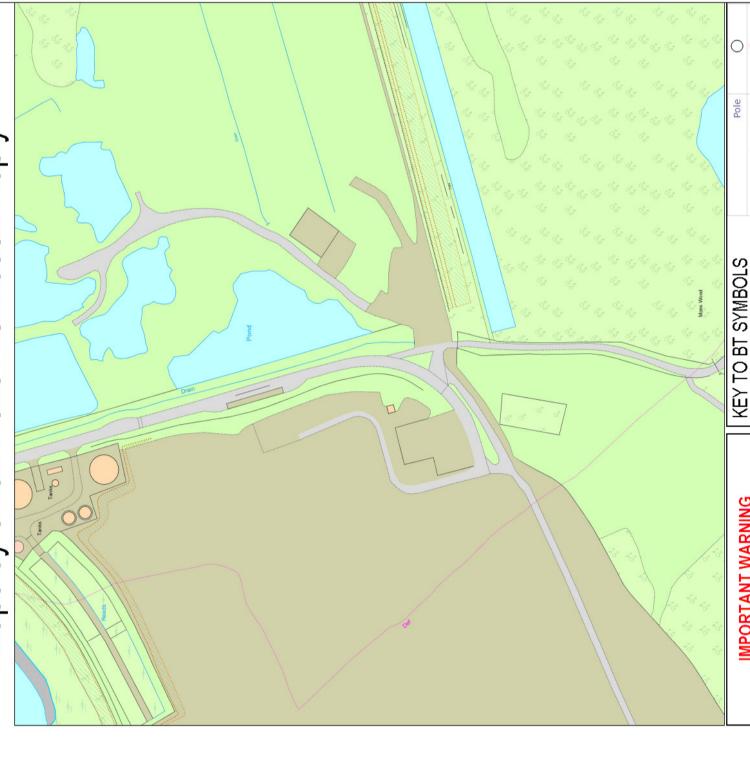
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BT Ref: MSC01281E

Map Reference : (centre) SJ5682385377 Easting/Northing : (centre) 356823,385377

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Planned Cabinet

Hatchings

Other proposed plant is shown using dashed lines BT Symbols not listed above maybe disregarded. Existing BT Plant may not be recorded. Information valid at time of preparation
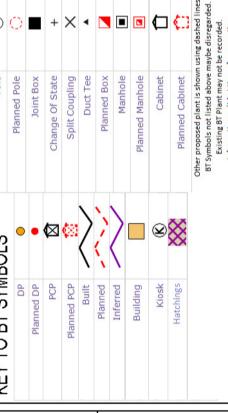
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PCP DP Built Planned Inferred Building Planned DP Planned PCP

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Cabinet

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Change Of State Split Coupling Duct Tee Planned Box Manhole Planned Manhole

Planned Pole Joint Box

BT Ref: OFB01161N

Map Reference : (centre) SJ5892486373 Easting/Northing : (centre) 358924,386373

Issued: 15/03/2018 13:16:31



IMPORTANT WARNING

Information regarding the location of BT apparatus is given for your assistance and is intended for general guidance only.

No guarantee is given of its accuracy.

It should not be relied upon in the event of excavations or other works being made near to BT apparatus which may exist at various depths and may deviate from the marked route.



openreach

CLICK BEFORE YOU DIG
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Hatchings

ADVANCE NO ITCE REQUIRED
(Office hours: Monday - Friday 08.00 to 17.00)
www.openreach.co.ul/cbyd

Reproduced from the Ordnance Survey map by BT by permission of Ordnance Survey on behalf of the Controller of Her Majesty's Stationary Office (C) Crown Copyright British Telecommunications plc 100028040

Planned Pole Change Of State Split Coupling Duct Tee Planned Box Manhole Planned Manhole Joint Box PCP DP Planned Inferred Building Planned DP Planned PCP Built

× **→ ■**

+

BT Ref: RLY01274K

Other proposed plant is shown using dashed lines.
BY Symbols not listed above maybe disregarded.
Existing BY Plant may not be recorded.

Map Reference : (centre) SJ5689985587 Easting/Northing : (centre) 356899,385587

Issued: 15/03/2018 13:27:15

Shepherd Gilmour Consulting Engineers

www.shepherd-gilmour.co.uk

APPENDIX F



SGi Consulting

FAO:

How to contact us:

Telephone:

Your Ref: Port Warrington South Our Ref: UUPS-ORD-22247

Date: 05/04/2018

E-mail:

Dear Sirs

Location: Port Warrington Birch Wood

I acknowledge with thanks your request dated 05/04/2018 for information on the location of our services.

Please find enclosed plans showing the approximate position of United Utilities' apparatus known to be in the vicinity of this site.

The enclosed plans are being provided to you subject to the United Utilities terms and conditions for both the wastewater and water distribution plans which are shown attached.

If you are planning works anywhere in the North West, please read United Utilities' access statement before you start work to check how it will affect our network. http://www.unitedutilities.com/work-near-asset.aspx.

I trust the above meets with your requirements and look forward to hearing from you should you need anything further.

If you have any queries regarding this matter please contact us.

Yours Faithfully,





TERMS AND CONDITIONS - WASTERWATER AND WATER DISTRIBUTION PLANS


These provisions apply to the public sewerage, water distribution and telemetry systems (including sewers which are the subject of an agreement under Section 104 of the Water Industry Act 1991 and mains installed in accordance with the agreement for the self construction of water mains) (UUWL apparatus) of United Utilities Water Limited "(UUWL)".

TERMS AND CONDITIONS:


- This Map and any information supplied with it is issued subject to the provisions contained below, to the exclusion of all others and no party relies upon any representation, warranty, collateral contract or other assurance of any person (whether party to this agreement or not) that is not set out in this agreement or the documents referred to in it.
- This Map and any information supplied with it is provided for general guidance only and no representation, undertaking or warranty as to its accuracy, completeness or being up to date is given or implied.
- In particular, the position and depth of any UUWL apparatus shown on the Map are approximate only. UUWL strongly recommends that a comprehensive survey is undertaken in addition to reviewing this Map to determine and ensure the precise location of any UUWL apparatus. The exact location, positions and depths should be obtained by excavation trial holes.
- The location and position of private drains, private sewers and service pipes to properties are not normally shown on this Map but their presence must be anticipated and accounted for and you are strongly advised to carry out your own further enquiries and investigations in order to locate the same.
- The position and depth of UUWL apparatus is subject to change and therefore this Map is issued subject to any removal or change in location of the same. The onus is entirely upon you to confirm whether any changes to the Map have been made subsequent to issue and prior to any works being carried out.
- This Map and any information shown on it or provided with it must not be relied upon in the event of any development, construction or other works (including but not limited to any excavations) in the vicinity of UUWL apparatus or for the purpose of determining the suitability of a point of connection to the sewerage or other distribution systems.
- No person or legal entity, including any company shall be relieved from any liability howsoever and whensoever arising for any damage caused to UUWL apparatus by reason of the actual position and/or depths of UUWL apparatus being different from those shown on the Map and any information supplied with it.
- If any provision contained herein is or becomes legally invalid or unenforceable, it will be taken to be severed from the remaining provisions which shall be unaffected and continue in full force and affect.
- This agreement shall be governed by English law and all parties submit to the exclusive jurisdiction of the English courts, save that nothing will prevent UUWL from bringing proceedings in any other competent jurisdiction, whether concurrently or otherwise.



Clean Water Symbology

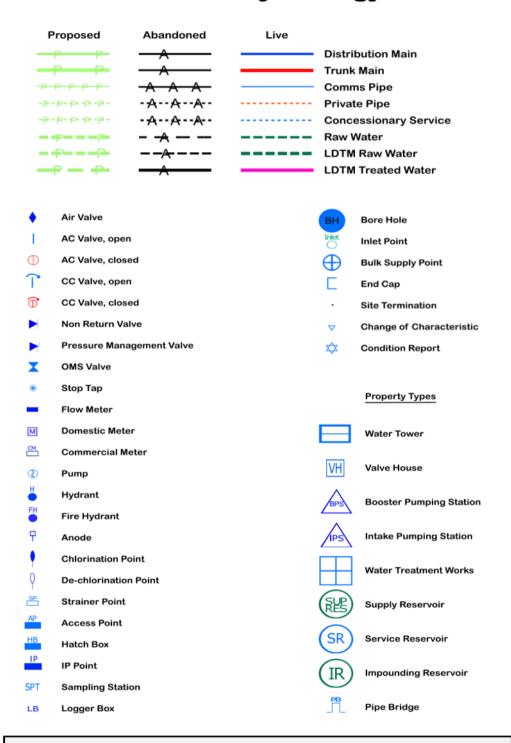

Symbology for proposed assets is the same as above, but shown in green Symbology for abandoned assets is the same as above, but shown in black

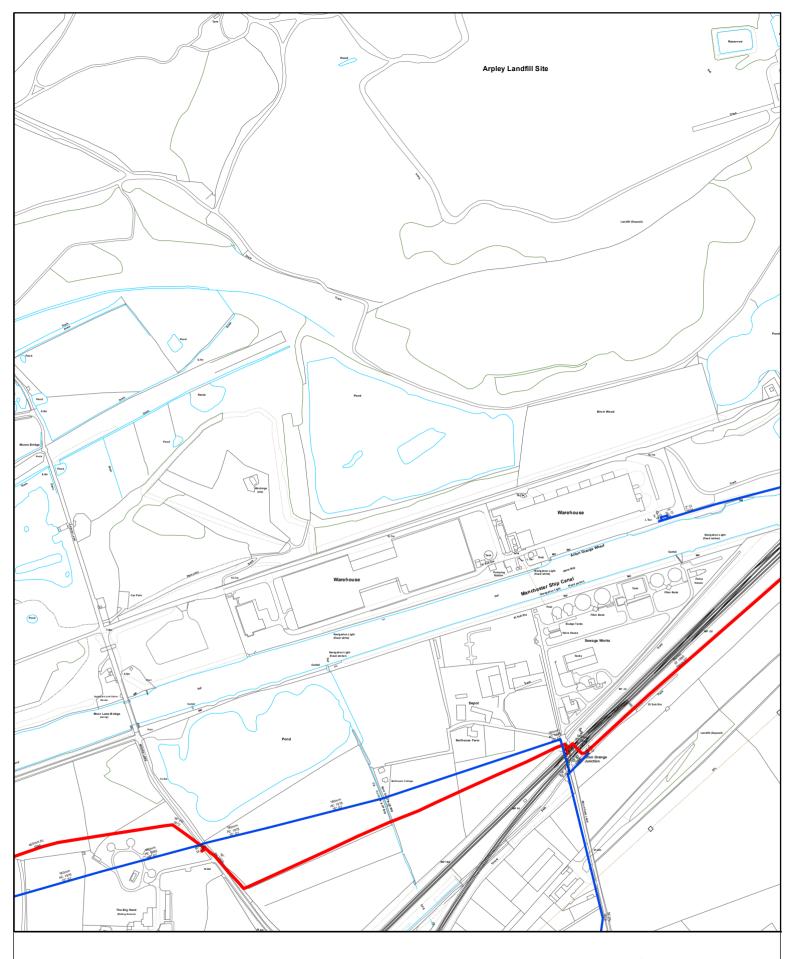

Date: 05/04/2018

Extract from Map Of Water Mains

Printed By: Property Searches

Port Warrington Birch Wood



The position of this underground apparatus shown on this plan is approximate only and is given in accordance with the best information currently available. The actual positions may be different from those shown on the plan, private service pipes may be shown where a known record is available. United Utilities Water will not accept liability for any loss or damage caused by the actual position being different from those shown. Crown copyright and database rights [2016] Ordnance Survey 100022432.

United Utilities Water Limited 2014 The plan is based on the Ordnance Survey Map with the sanction of Controller of H.M.Stationery Office. Crown and Utilities copyrights are reserved. Unauthorised reproduction will infringe these copyrights.



SGi Consulting

FAO:

How to contact us:

Telephone:

Your Ref: Port Warrington North Our Ref: UUPS-ORD-22248

Date: 05/04/2018

E-mail:

Dear Sirs

Location: Port Warrington Landfill

I acknowledge with thanks your request dated 05/04/2018 for information on the location of our services.

Please find enclosed plans showing the approximate position of United Utilities' apparatus known to be in the vicinity of this site.

The enclosed plans are being provided to you subject to the United Utilities terms and conditions for both the wastewater and water distribution plans which are shown attached.

If you are planning works anywhere in the North West, please read United Utilities' access statement before you start work to check how it will affect our network. http://www.unitedutilities.com/work-near-asset.aspx.

I trust the above meets with your requirements and look forward to hearing from you should you need anything further.

If you have any queries regarding this matter please contact us.

Yours Faithfully,





TERMS AND CONDITIONS - WASTERWATER AND WATER DISTRIBUTION PLANS


These provisions apply to the public sewerage, water distribution and telemetry systems (including sewers which are the subject of an agreement under Section 104 of the Water Industry Act 1991 and mains installed in accordance with the agreement for the self construction of water mains) (UUWL apparatus) of United Utilities Water Limited "(UUWL)".

TERMS AND CONDITIONS:


- This Map and any information supplied with it is issued subject to the provisions contained below, to the exclusion of all others and no party relies upon any representation, warranty, collateral contract or other assurance of any person (whether party to this agreement or not) that is not set out in this agreement or the documents referred to in it.
- This Map and any information supplied with it is provided for general guidance only and no representation, undertaking or warranty as to its accuracy, completeness or being up to date is given or implied.
- In particular, the position and depth of any UUWL apparatus shown on the Map are approximate only. UUWL strongly recommends that a comprehensive survey is undertaken in addition to reviewing this Map to determine and ensure the precise location of any UUWL apparatus. The exact location, positions and depths should be obtained by excavation trial holes.
- The location and position of private drains, private sewers and service pipes to properties are not normally shown on this Map but their presence must be anticipated and accounted for and you are strongly advised to carry out your own further enquiries and investigations in order to locate the same.
- The position and depth of UUWL apparatus is subject to change and therefore this Map is issued subject to any removal or change in location of the same. The onus is entirely upon you to confirm whether any changes to the Map have been made subsequent to issue and prior to any works being carried out.
- This Map and any information shown on it or provided with it must not be relied upon in the event of any development, construction or other works (including but not limited to any excavations) in the vicinity of UUWL apparatus or for the purpose of determining the suitability of a point of connection to the sewerage or other distribution systems.
- No person or legal entity, including any company shall be relieved from any liability howsoever and whensoever arising for any damage caused to UUWL apparatus by reason of the actual position and/or depths of UUWL apparatus being different from those shown on the Map and any information supplied with it.
- If any provision contained herein is or becomes legally invalid or unenforceable, it will be taken to be severed from the remaining provisions which shall be unaffected and continue in full force and affect.
- This agreement shall be governed by English law and all parties submit to the exclusive jurisdiction of the English courts, save that nothing will prevent UUWL from bringing proceedings in any other competent jurisdiction, whether concurrently or otherwise.



Clean Water Symbology

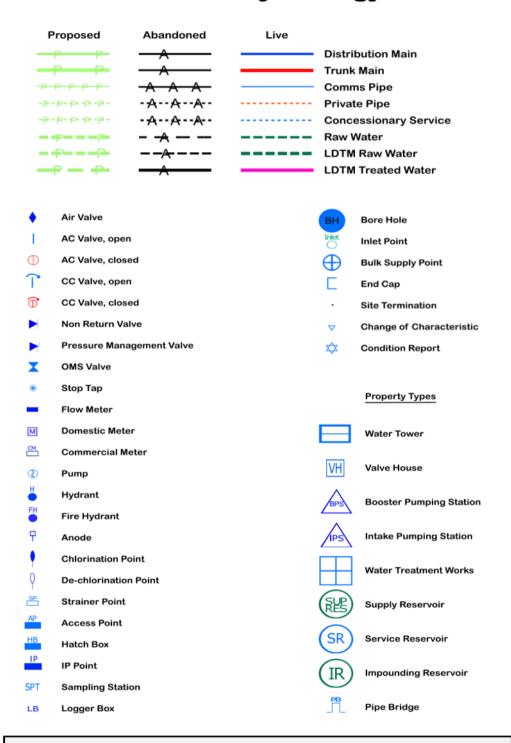

Symbology for proposed assets is the same as above, but shown in green Symbology for abandoned assets is the same as above, but shown in black

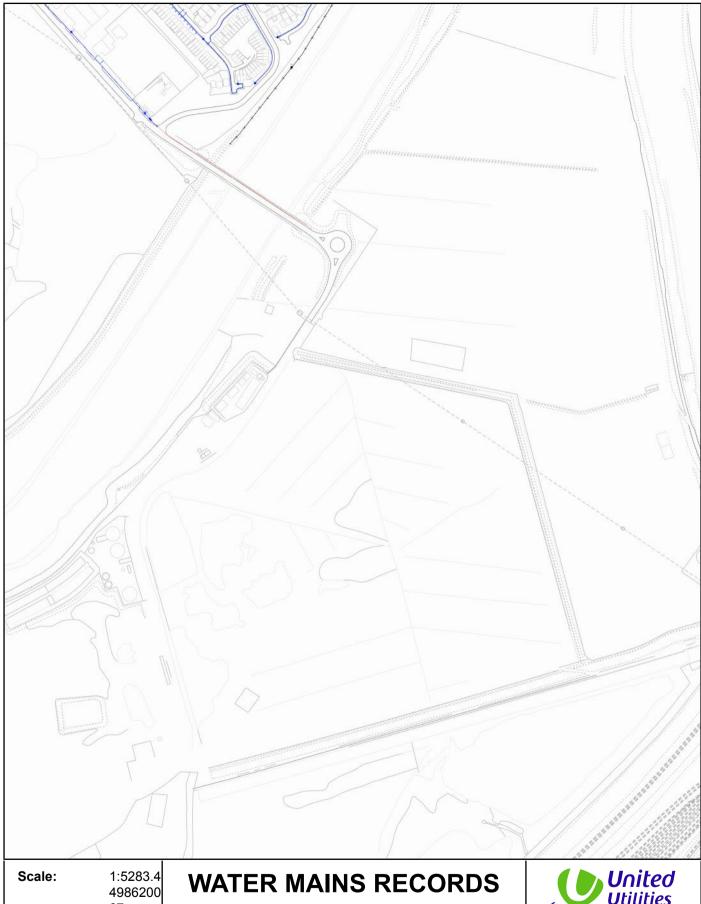

67

05/04/20 Date:

18



Address or Site Reference: Port Warrington Landfill


> Printed by: **Property Searches**

The position of the underground apparatus shown on this plan is approximate only and is given in accordance with the best information currently available. United Utilities Water will not accept liability for any loss or damage caused by the actual position being different from those shown.

Shepherd Gilmour Consulting Engineers

APPENDIX G



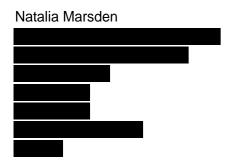

Date: 16/03/2018

Our Ref: NW_TW_Z1_3SWX_413318
Your Ref: Port Warrington Central

RE: Proposed Works, Port Warrington Central, Cheshire

Thank you for your enquiry which was received on 16/03/2018.

Please note this response and any attached map(s) are valid for 28 days.

An assessment has been carried out with respect to Cadent Gas Ltd, National Grid Electricity Transmission plc's and National Grid Gas plc's apparatus. Please note it does not cover the items listed in the section "Your Responsibilities and Obligations", including gas service pipes and related apparatus.

For details of Network areas please see the Cadent website (http://cadentgas.com/Digging-safely/Dial-before-you-dig) or the enclosed documentation.

As your works are at a "proposed" stage, any maps and guidance provided are for information purposes only. This is not approval to commence work. You must submit a "Scheduled Works" enquiry at the earliest opportunity and failure to do this may lead to disruption to your plans and works. Plant Protection will endeavour to provide an <u>initial</u> assessment within 14 days of receipt of a Scheduled Works enquiry and dependent on the outcome of this, further consultation may be required.

In any event, for safety and legal reasons, works must not be carried out until a Scheduled Works enquiry has been completed and final response received.



National Gas Emergency Number: 0800 111 999*

National Grid Electricity Emergency Number: 0800 40 40 90*

* Available 24 hours, 7 days/week. Calls may be recorded and monitored.

www.cadentgas.com

Your Responsibilities and Obligations

The "Assessment" Section below outlines the detailed requirements that must be followed when planning or undertaking your scheduled activities at this location.

It is your responsibility to ensure that the information you have submitted is accurate and that all relevant documents including links are provided to all persons (either direct labour or contractors) working for you near Cadent and/or National Grid's apparatus, e.g. as contained within the Construction (Design and Management) Regulations.

This assessment solely relates to Cadent Gas Ltd, National Grid Electricity Transmission plc (NGET) and National Grid Gas plc (NGG) and apparatus. This assessment does **NOT** include:

- Cadent and/or National Grid's legal interest (easements or wayleaves) in the land which restricts
 activity in proximity to Cadent and/or National Grid's assets in private land. You must obtain details of
 any such restrictions from the landowner in the first instance and if in doubt contact Plant Protection.
- Gas service pipes and related apparatus
- Recently installed apparatus
- Apparatus owned by other organisations, e.g. other gas distribution operators, local electricity companies, other utilities, etc.

It is **YOUR** responsibility to take into account whether the items listed above may be present and if they could be affected by your proposed activities. Further "Essential Guidance" in respect of these items can be found on the National Grid Website (https://www2.nationalgrid.com/WorkArea/DownloadAsset.aspx?id=8589934982).

This communication does not constitute any formal agreement or consent for any proposed development work; either generally or with regard to Cadent and/or National Grid's easements or wayleaves nor any planning or building regulations applications.

Cadent Gas Ltd, NGG and NGET or their agents, servants or contractors do not accept any liability for any losses arising under or in connection with this information. This limit on liability applies to all and any claims in contract, tort (including negligence), misrepresentation (excluding fraudulent misrepresentation), breach of statutory duty or otherwise. This limit on liability does not exclude or restrict liability where prohibited by the law nor does it supersede the express terms of any related agreements.

If you require further assistance please contact the Plant Protection team via e-mail (<u>click here</u>) or via the contact details at the top of this response.

Yours faithfully

Plant Protection Team

ASSESSMENT

Affected Apparatus

The apparatus that has been identified as being in the vicinity of your proposed works is:

• High or Intermediate pressure (above 2 bar) Gas Pipelines and associated equipment

Requirements

BEFORE carrying out any work you must:

- Carefully read these requirements including the attached guidance documents and maps showing the location of apparatus.
- Contact the landowner and ensure any proposed works in private land do not infringe Cadent and/or National Grid's legal rights (i.e. easements or wayleaves). If the works are in the road or footpath the relevant local authority should be contacted.
- Ensure that all persons, including direct labour and contractors, working for you on or near Cadent and/or National Grid's apparatus follow the requirements of the HSE Guidance Notes HSG47 'Avoiding Danger from Underground Services' and GS6 'Avoidance of danger from overhead electric power lines'. This guidance can be downloaded free of charge at http://www.hse.gov.uk
- In line with the above guidance, verify and establish the actual position of mains, pipes, cables, services and other apparatus on site before any activities are undertaken.

GUIDANCE

High Pressure Gas Pipelines Guidance:

If working in the vicinity of a high pressure gas pipeline the following document must be followed: 'Specification for Safe Working in the Vicinity of Cadent and/or National Grid High Pressure Gas Pipelines and Associated Installations - Requirements for Third Parties' (SSW22). This can be obtained from: http://www2.nationalgrid.com/WorkArea/DownloadAsset.aspx?id=33968

Dial Before You Dig Pipelines Guidance:

http://www2.nationalgrid.com/WorkArea/DownloadAsset.aspx?id=33969

Standard Guidance

Essential Guidance document:

http://www2.nationalgrid.com/WorkArea/DownloadAsset.aspx?id=8589934982

General Guidance document:

http://www2.nationalgrid.com/WorkArea/DownloadAsset.aspx?id=35103


Excavating Safely in the vicinity of gas pipes guidance (Credit card):

http://www.nationalgrid.com/NR/rdonlyres/A3D37677-6641-476C-9DDA-E89949052829/44257/ExcavatingSafelyCreditCard.pdf

Excavating Safely in the vicinity of electricity cables guidance (Credit card):

http://www.nationalgrid.com/NR/rdonlyres/35DDEC6D-D754-4BA5-AF3C-D607D05A25C2/44858/ExcavatingSafelyCreditCardelectricitycables.pdf

Copies of all the Guidance Documents can also be downloaded from the National Grid Website: http://www.nationalgrid.com/uk/Gas/Safety/work/downloads/

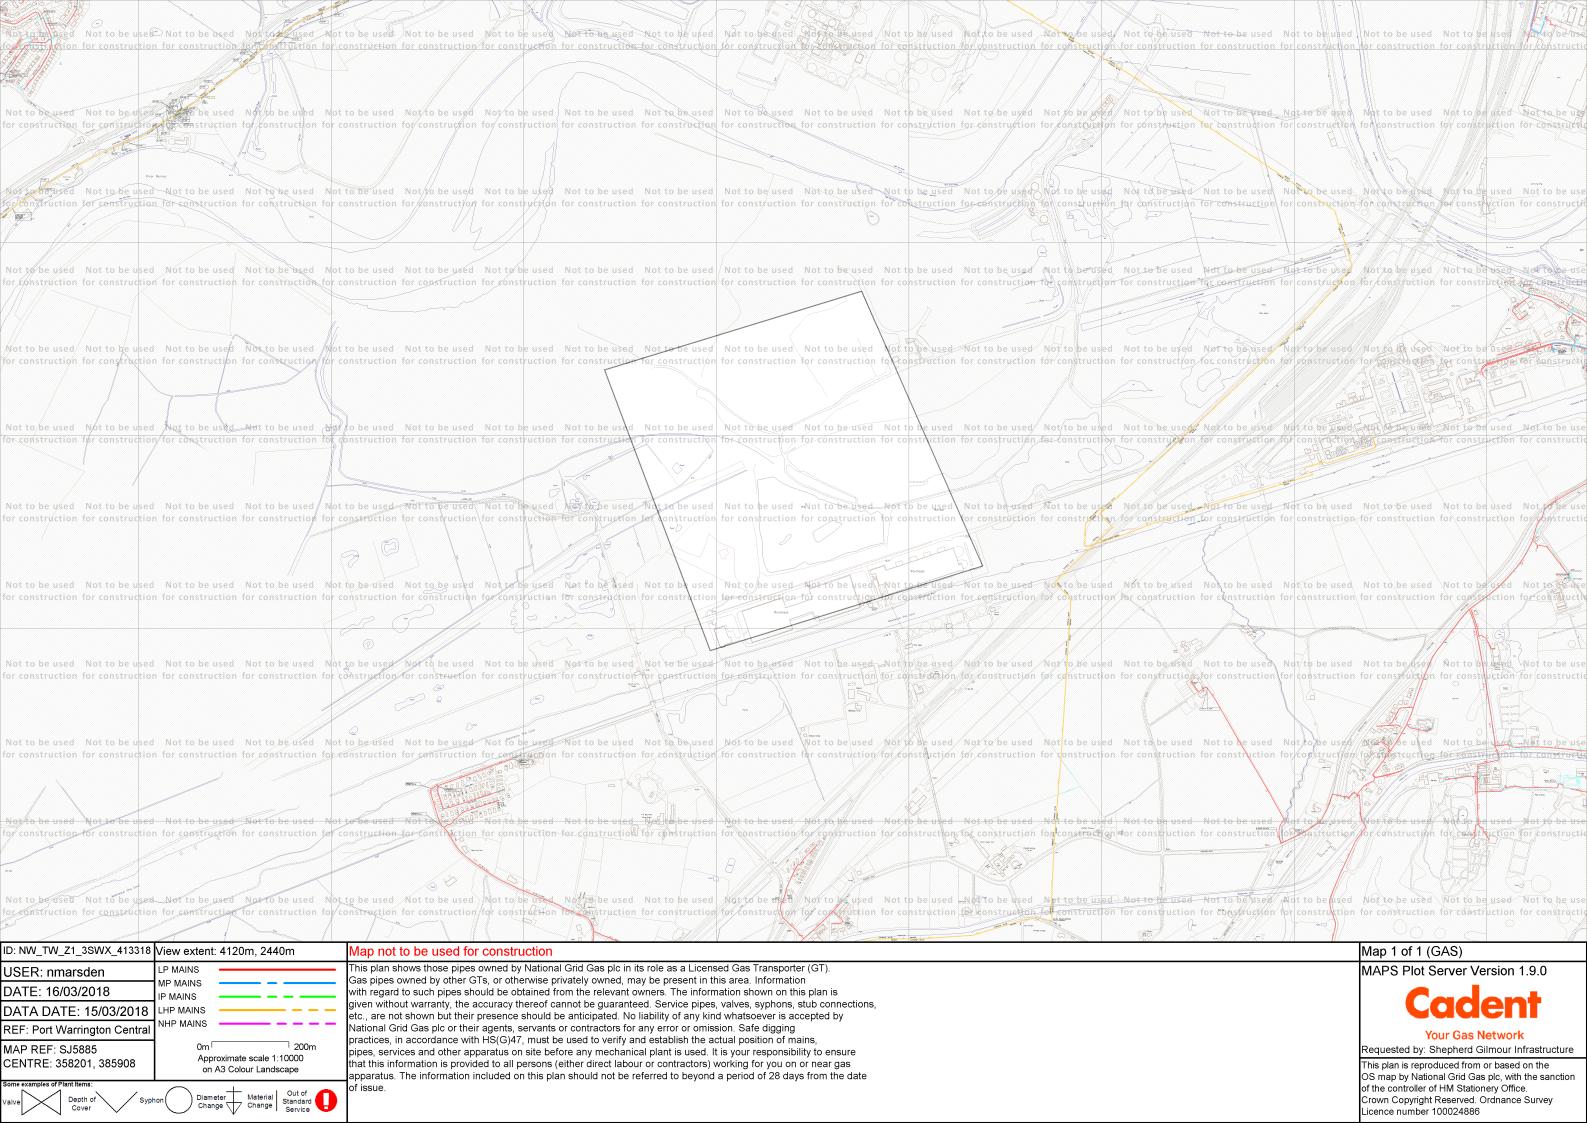

ENQUIRY SUMMARY

Received Date

16/03/2018

Your Reference

Port Warrington Central

Location

Centre Point: 358201, 385908

X Extent: 985 Y Extent: 935

Postcode: WA4 6YZ

Location Description: Port Warrington Central, Cheshire

Map Options Paper Size: A3

Orientation: LANDSCAPE Requested Scale: 10000 Actual Scale: 1:10000 (GAS)

Real World Extents: 4120m x 2440m (GAS)

Recipients

Enquirer Details

Organisation Name: Shepherd Gilmour Infrastructure

Contact Name: Natalia Marsden

Email Address:

Telephone:

Address:

Description of Works

Proposed industrial/commercial development

Enquiry Type

Proposed Works


Activity Type

Development Project

Work Types

Work Type: Plans Only



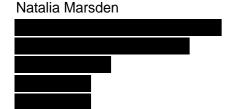

Date: 16/03/2018

Our Ref: NW_TW_Z1_3SWX_413315
Your Ref: Port Warrington East

RE: Proposed Works, Port Warrington East, Cheshire

Thank you for your enquiry which was received on 16/03/2018.

Please note this response and any attached map(s) are valid for 28 days.

An assessment has been carried out with respect to Cadent Gas Ltd, National Grid Electricity Transmission plc's and National Grid Gas plc's apparatus. Please note it does not cover the items listed in the section "Your Responsibilities and Obligations", including gas service pipes and related apparatus.

For details of Network areas please see the Cadent website (http://cadentgas.com/Digging-safely/Dial-before-you-dig) or the enclosed documentation.

As your works are at a "proposed" stage, any maps and guidance provided are for information purposes only. This is not approval to commence work. You must submit a "Scheduled Works" enquiry at the earliest opportunity and failure to do this may lead to disruption to your plans and works. Plant Protection will endeavour to provide an <u>initial</u> assessment within 14 days of receipt of a Scheduled Works enquiry and dependent on the outcome of this, further consultation may be required.

In any event, for safety and legal reasons, works must not be carried out until a Scheduled Works enquiry has been completed and final response received.



National Gas Emergency Number: 0800 111 999*

National Grid Electricity Emergency Number: 0800 40 40 90*

* Available 24 hours, 7 days/week. Calls may be recorded and monitored.

www.cadentgas.com

Your Responsibilities and Obligations

The "Assessment" Section below outlines the detailed requirements that must be followed when planning or undertaking your scheduled activities at this location.

It is your responsibility to ensure that the information you have submitted is accurate and that all relevant documents including links are provided to all persons (either direct labour or contractors) working for you near Cadent and/or National Grid's apparatus, e.g. as contained within the Construction (Design and Management) Regulations.

This assessment solely relates to Cadent Gas Ltd, National Grid Electricity Transmission plc (NGET) and National Grid Gas plc (NGG) and apparatus. This assessment does **NOT** include:

- Cadent and/or National Grid's legal interest (easements or wayleaves) in the land which restricts
 activity in proximity to Cadent and/or National Grid's assets in private land. You must obtain details of
 any such restrictions from the landowner in the first instance and if in doubt contact Plant Protection.
- Gas service pipes and related apparatus
- Recently installed apparatus
- Apparatus owned by other organisations, e.g. other gas distribution operators, local electricity companies, other utilities, etc.

It is **YOUR** responsibility to take into account whether the items listed above may be present and if they could be affected by your proposed activities. Further "Essential Guidance" in respect of these items can be found on the National Grid Website (https://www2.nationalgrid.com/WorkArea/DownloadAsset.aspx?id=8589934982).

This communication does not constitute any formal agreement or consent for any proposed development work; either generally or with regard to Cadent and/or National Grid's easements or wayleaves nor any planning or building regulations applications.

Cadent Gas Ltd, NGG and NGET or their agents, servants or contractors do not accept any liability for any losses arising under or in connection with this information. This limit on liability applies to all and any claims in contract, tort (including negligence), misrepresentation (excluding fraudulent misrepresentation), breach of statutory duty or otherwise. This limit on liability does not exclude or restrict liability where prohibited by the law nor does it supersede the express terms of any related agreements.

If you require further assistance please contact the Plant Protection team via e-mail (<u>click here</u>) or via the contact details at the top of this response.

Yours faithfully

Plant Protection Team

ASSESSMENT

Affected Apparatus

The apparatus that has been identified as being in the vicinity of your proposed works is:

• High or Intermediate pressure (above 2 bar) Gas Pipelines and associated equipment

Requirements

BEFORE carrying out any work you must:

- Carefully read these requirements including the attached guidance documents and maps showing the location of apparatus.
- Contact the landowner and ensure any proposed works in private land do not infringe Cadent and/or National Grid's legal rights (i.e. easements or wayleaves). If the works are in the road or footpath the relevant local authority should be contacted.
- Ensure that all persons, including direct labour and contractors, working for you on or near Cadent and/or National Grid's apparatus follow the requirements of the HSE Guidance Notes HSG47 'Avoiding Danger from Underground Services' and GS6 'Avoidance of danger from overhead electric power lines'. This guidance can be downloaded free of charge at http://www.hse.gov.uk
- In line with the above guidance, verify and establish the actual position of mains, pipes, cables, services and other apparatus on site before any activities are undertaken.

GUIDANCE

High Pressure Gas Pipelines Guidance:

If working in the vicinity of a high pressure gas pipeline the following document must be followed: 'Specification for Safe Working in the Vicinity of Cadent and/or National Grid High Pressure Gas Pipelines and Associated Installations - Requirements for Third Parties' (SSW22). This can be obtained from: http://www2.nationalgrid.com/WorkArea/DownloadAsset.aspx?id=33968

Dial Before You Dig Pipelines Guidance:

http://www2.nationalgrid.com/WorkArea/DownloadAsset.aspx?id=33969

Standard Guidance

Essential Guidance document:

http://www2.nationalgrid.com/WorkArea/DownloadAsset.aspx?id=8589934982

General Guidance document:

http://www2.nationalgrid.com/WorkArea/DownloadAsset.aspx?id=35103

Excavating Safely in the vicinity of gas pipes guidance (Credit card):

http://www.nationalgrid.com/NR/rdonlyres/A3D37677-6641-476C-9DDA-E89949052829/44257/ExcavatingSafelyCreditCard.pdf

Excavating Safely in the vicinity of electricity cables guidance (Credit card):

http://www.nationalgrid.com/NR/rdonlyres/35DDEC6D-D754-4BA5-AF3C-D607D05A25C2/44858/ExcavatingSafelyCreditCardelectricitycables.pdf

Copies of all the Guidance Documents can also be downloaded from the National Grid Website: http://www.nationalgrid.com/uk/Gas/Safety/work/downloads/



ENQUIRY SUMMARY

Received Date

16/03/2018

Your Reference

Port Warrington East

Location

Centre Point: 359128, 386362

X Extent: 1250 Y Extent: 1465 Postcode: WA4 6YZ

Location Description: Port Warrington East, Cheshire

Map Options

Paper Size: A3

Orientation: PORTRAIT Requested Scale: 10000 Actual Scale: 1:10000 (GAS)

Real World Extents: 2890m x 3670m (GAS)

Recipients

Enquirer Details

Organisation Name: Shepherd Gilmour Infrastructure

Contact Name: Natalia Marsden

Email Address:

Telephone:

Address:

Description of Works

Proposed industrial/commercial development

Enquiry Type

Proposed Works

Activity Type

Development Project

Work Types

Work Type: Plans Only



APPENDIX H




Advice: HSL-180319151449-432 Crosses Consultation Zone

Please enter further details about the proposed development by continuing with the enquiry on the HSE's Planning Advice Web App from the Previous Enquiries tab either now or at a later time, unless the Web App has stopped the process and notified you to contact HSE.

Your Ref: Port Warrington Part1

Development Name:

Comments:

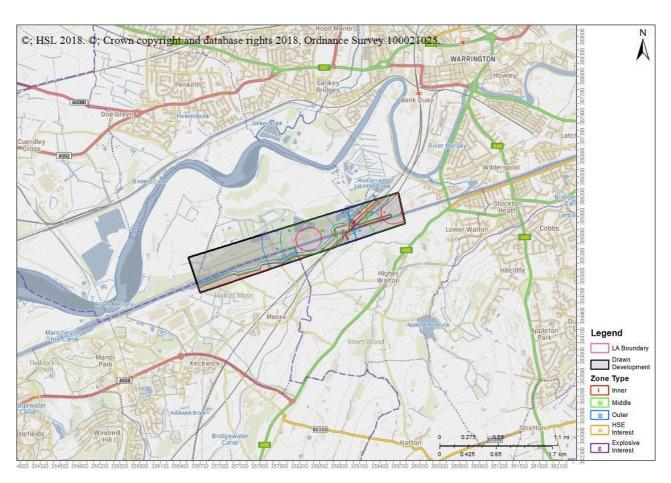

Commercial In Confidence

The proposed development site which you have identified currently lies within the consultation distance (CD) of at least one major hazard site and/or major accident hazard pipeline; HSE needs to be consulted on any developments on this site.

This advice report has been generated using information supplied by Dean O'Reilly at Shepherd Gilmour Infrastructure on 19 March 2018.

You will also need to contact the pipeline operator as they may have additional constraints on development near their pipeline.

- 6710 Sabic UK Petrochemicals Ltd
- 6772 1056 Cadent Gas Ltd

- 6773_1057 Cadent Gas Ltd
- 6783_1064 Cadent Gas Ltd

HSL/HSE accepts no liability for the accuracy of the pipeline routing data received from a 3rd party. HSE/HSL also accepts no liability if you do not consult with the pipeline operator.

You may wish to contact HSE's Planning Advice team to discuss the above enquiry result on or by email at




Advice: HSL-180319151708-432 Crosses Consultation Zone

Please enter further details about the proposed development by continuing with the enquiry on the HSE's Planning Advice Web App from the Previous Enquiries tab either now or at a later time, unless the Web App has stopped the process and notified you to contact HSE.

Your Ref: Port Warrington Part2

Development Name:

Comments:

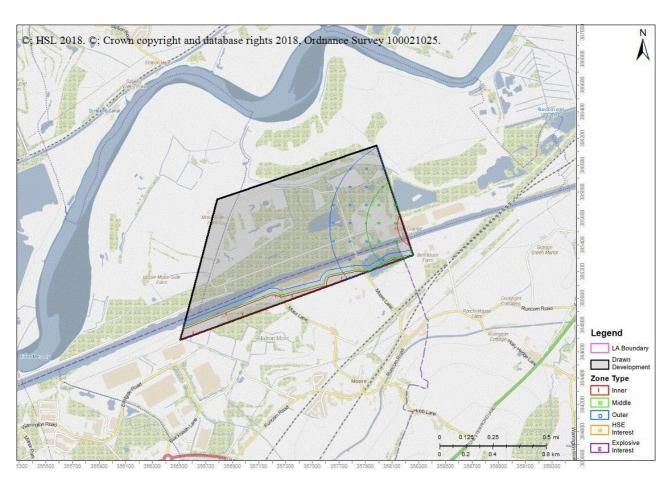

Commercial In Confidence

The proposed development site which you have identified currently lies within the consultation distance (CD) of at least one major hazard site and/or major accident hazard pipeline; HSE needs to be consulted on any developments on this site.

This advice report has been generated using information supplied by Dean O'Reilly at Shepherd Gilmour Infrastructure on 19 March 2018.

You will also need to contact the pipeline operator as they may have additional constraints on development near their pipeline.

• 6710 Sabic UK Petrochemicals Ltd

You may wish to contact HSE's Planning Advice team to discuss the above enquiry result on or by email at

HSL/HSE accepts no liability for the accuracy of the pipeline routing data received from a 3rd party. HSE/HSL also accepts no liability if you do not consult with the pipeline operator.




Advice: HSL-180319151855-432 Crosses Consultation Zone

Please enter further details about the proposed development by continuing with the enquiry on the HSE's Planning Advice Web App from the Previous Enquiries tab either now or at a later time, unless the Web App has stopped the process and notified you to contact HSE.

Your Ref: Port Warrington Part3

Development Name:

Comments:

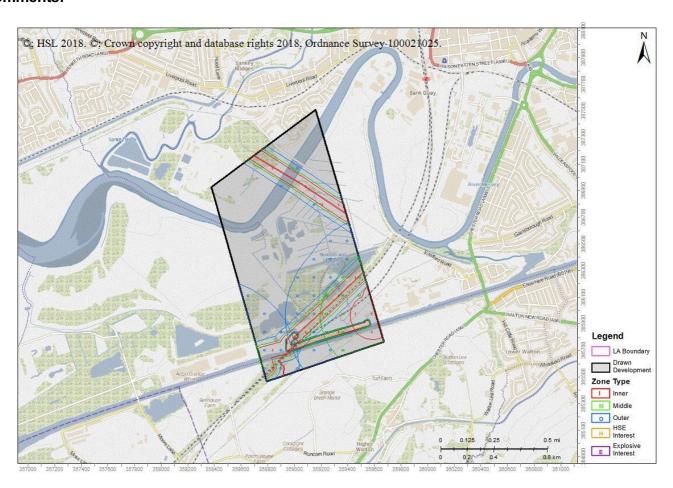

Commercial In Confidence

The proposed development site which you have identified currently lies within the consultation distance (CD) of at least one major hazard site and/or major accident hazard pipeline; HSE needs to be consulted on any developments on this site.

This advice report has been generated using information supplied by Dean O'Reilly at Shepherd Gilmour Infrastructure on 19 March 2018.

You will also need to contact the pipeline operator as they may have additional constraints on development near their pipeline.

- 6710 Sabic UK Petrochemicals Ltd
- 6772 1056 Cadent Gas Ltd

- 6773_1057 Cadent Gas Ltd
- 6783_1064 Cadent Gas Ltd

HSL/HSE accepts no liability for the accuracy of the pipeline routing data received from a 3rd party. HSE/HSL also accepts no liability if you do not consult with the pipeline operator.

You may wish to contact HSE's Planning Advice team to discuss the above enquiry result on or by email at




Advice: HSL-180319152016-432 Crosses Consultation Zone

Please enter further details about the proposed development by continuing with the enquiry on the HSE's Planning Advice Web App from the Previous Enquiries tab either now or at a later time, unless the Web App has stopped the process and notified you to contact HSE.

Your Ref: Port Warrington Part4

Development Name:

Comments:

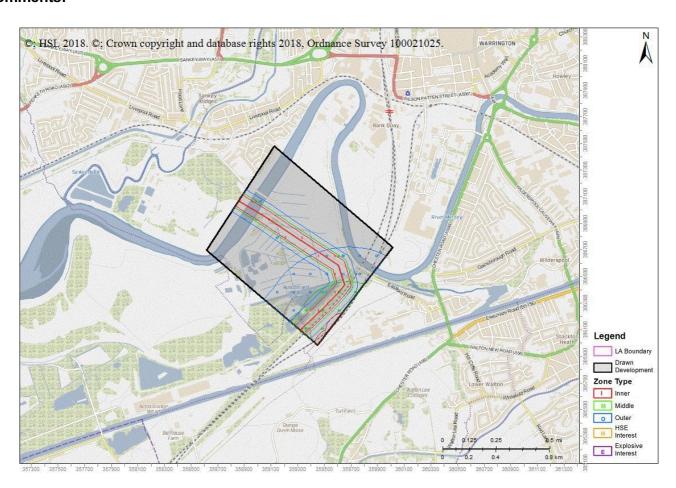

Commercial In Confidence

The proposed development site which you have identified currently lies within the consultation distance (CD) of at least one major hazard site and/or major accident hazard pipeline; HSE needs to be consulted on any developments on this site.

This advice report has been generated using information supplied by Dean O'Reilly at Shepherd Gilmour Infrastructure on 19 March 2018.

You will also need to contact the pipeline operator as they may have additional constraints on development near their pipeline.

- 6710 Sabic UK Petrochemicals Ltd
- 6783 1064 Cadent Gas Ltd

HSL/HSE accepts no liability for the accuracy of the pipeline routing data received from a 3rd party. HSE/HSL also accepts no liability if you do not consult with the pipeline operator.

You may wish to contact HSE's Planning Advice team to discuss the above enquiry result on or by email at



APPENDIX I

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